


FLOOR PLAN LAYOUT ICU
Scale: 1:100

- Client:**
1. All levels and dimensions to be checked on site before any building work commence
 2. All works to be strictly in accordance to with standard specification and notes
 3. walls below 200mm to be reinforced with hoop iron at every alternate course.
 4. This drawing is to be read in conjunction with specifications and all other relevant drawings


Client:	
Nis - Foundation	
project Name:	
Reconstruction of Lasanod hospital	
Drawing title:	
Drawing title:	
prepered by:	checked by:
XXXXXX	XXXXXX
Scale:	Date:
1:100	Feb - 2024
Drawing no:	Revision:
0001	

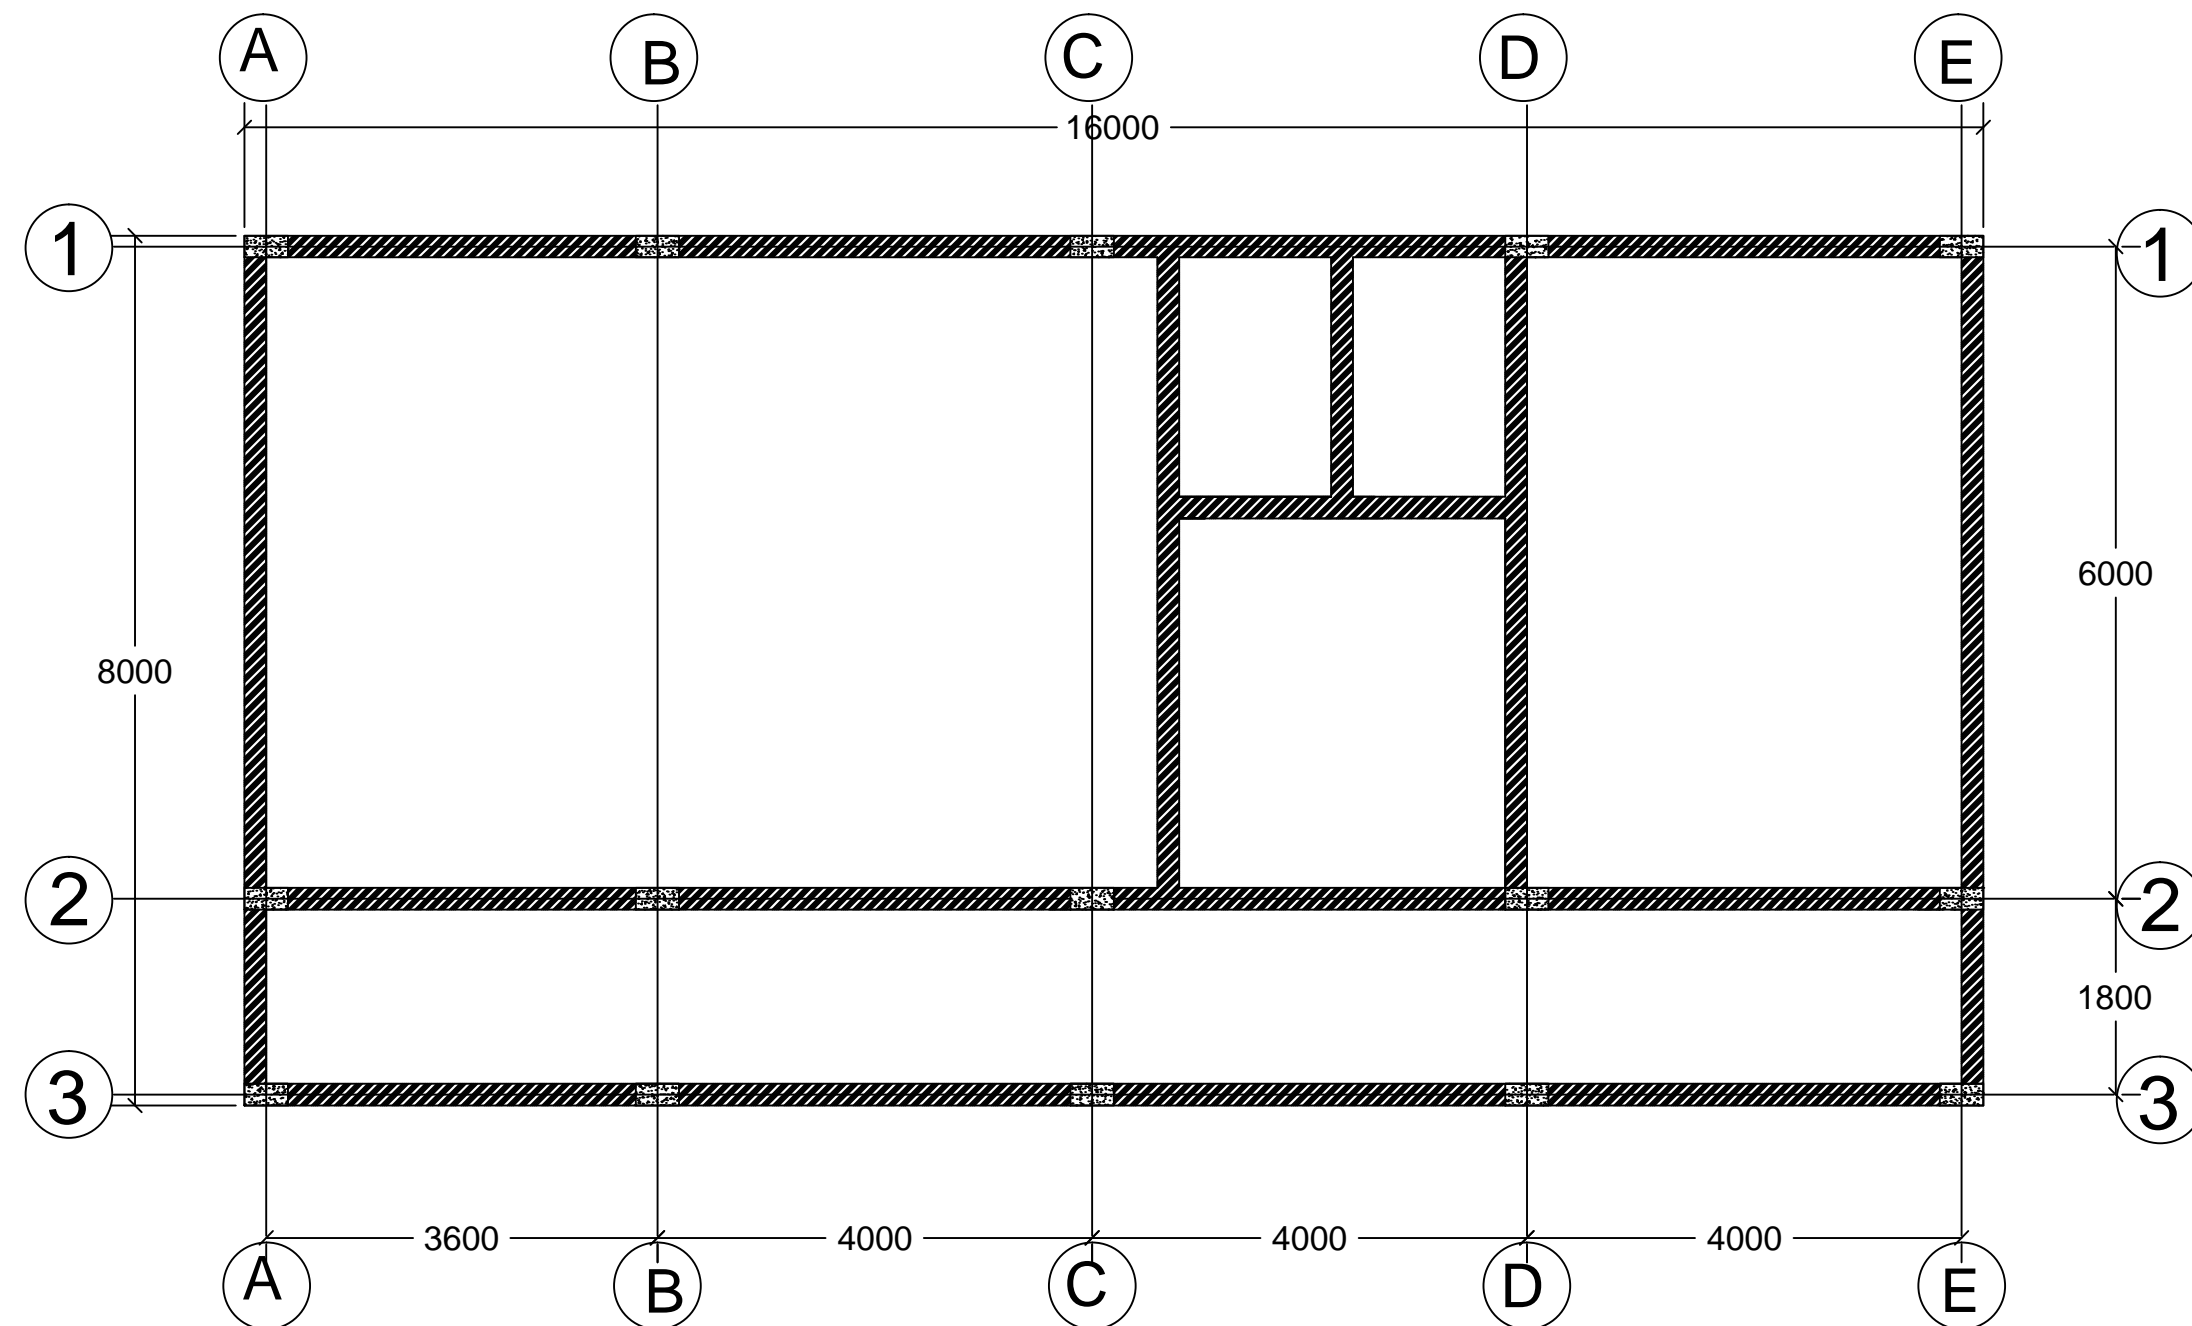

RING BEAM LAYOUT
Scale: 1:100

- Client:**
- 1. All levels and dimensions to be checked on site before any building work commence
 - 2.All works to be strictly in accordance to with standard specification and notes
 - 3. walls below 200mm to be reinforced with hoop iron at every alternate course.
 - 4. This drawing is to be read in conjunction with specifications and all other relevant drawings



Client:	
Nis - Foundation	
project Name:	
Reconstruction of Lasanod hospital	
Drawing title:	
Drawing title:	
prepered by:	checked by:
XXXXXX	XXXXXX
Scale:	Date:
1:100	Feb - 2024
Drawing no:	Revision:
0001	

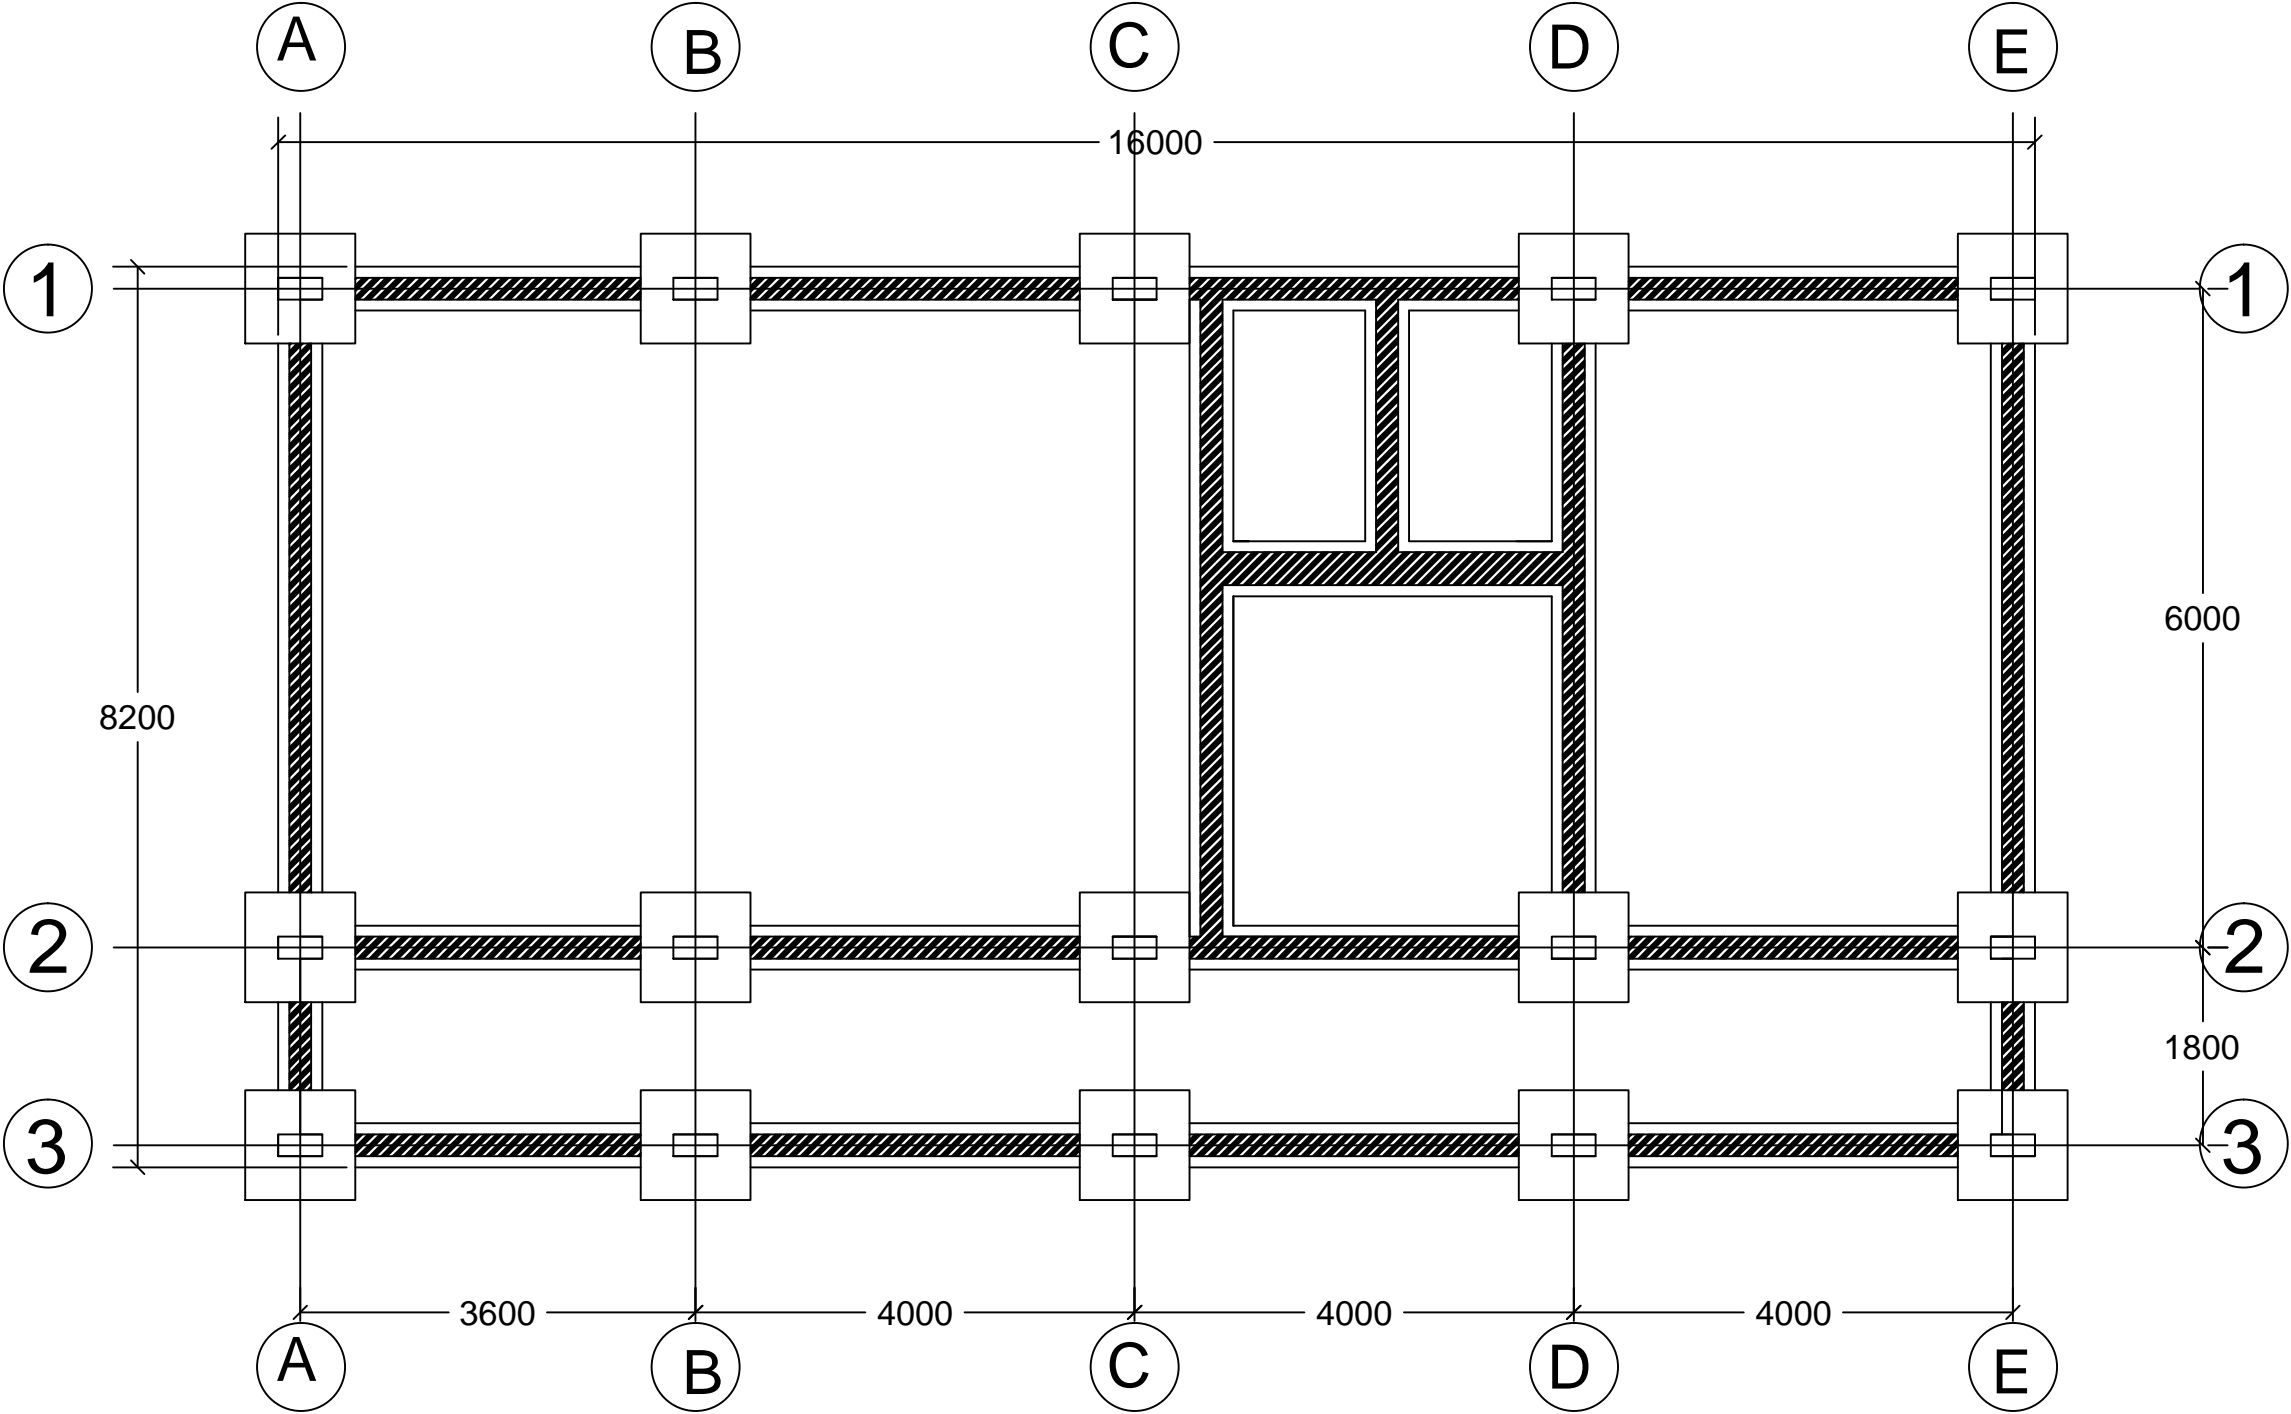

FOUNDATION PLAN
Scale: 1:100

- Client:
1. All levels and dimensions to be checked on site before any building work commence
 2. All works to be strictly in accordance to with standard specification and notes
 3. walls below 200mm to be reinforced with hoop iron at every alternate course.
 4. This drawing is to be read in conjunction with specifications and all other relevant drawings



Client:	
Nis - Foundation	
project Name:	
Reconstruction of Lasanod hospital	
Drawing title:	
Drawing title:	
prepered by:	checked by:
XXXXXX	XXXXXX
Scale:	Date:
1:100	Feb - 2024
Drawing no:	Revision:
0001	

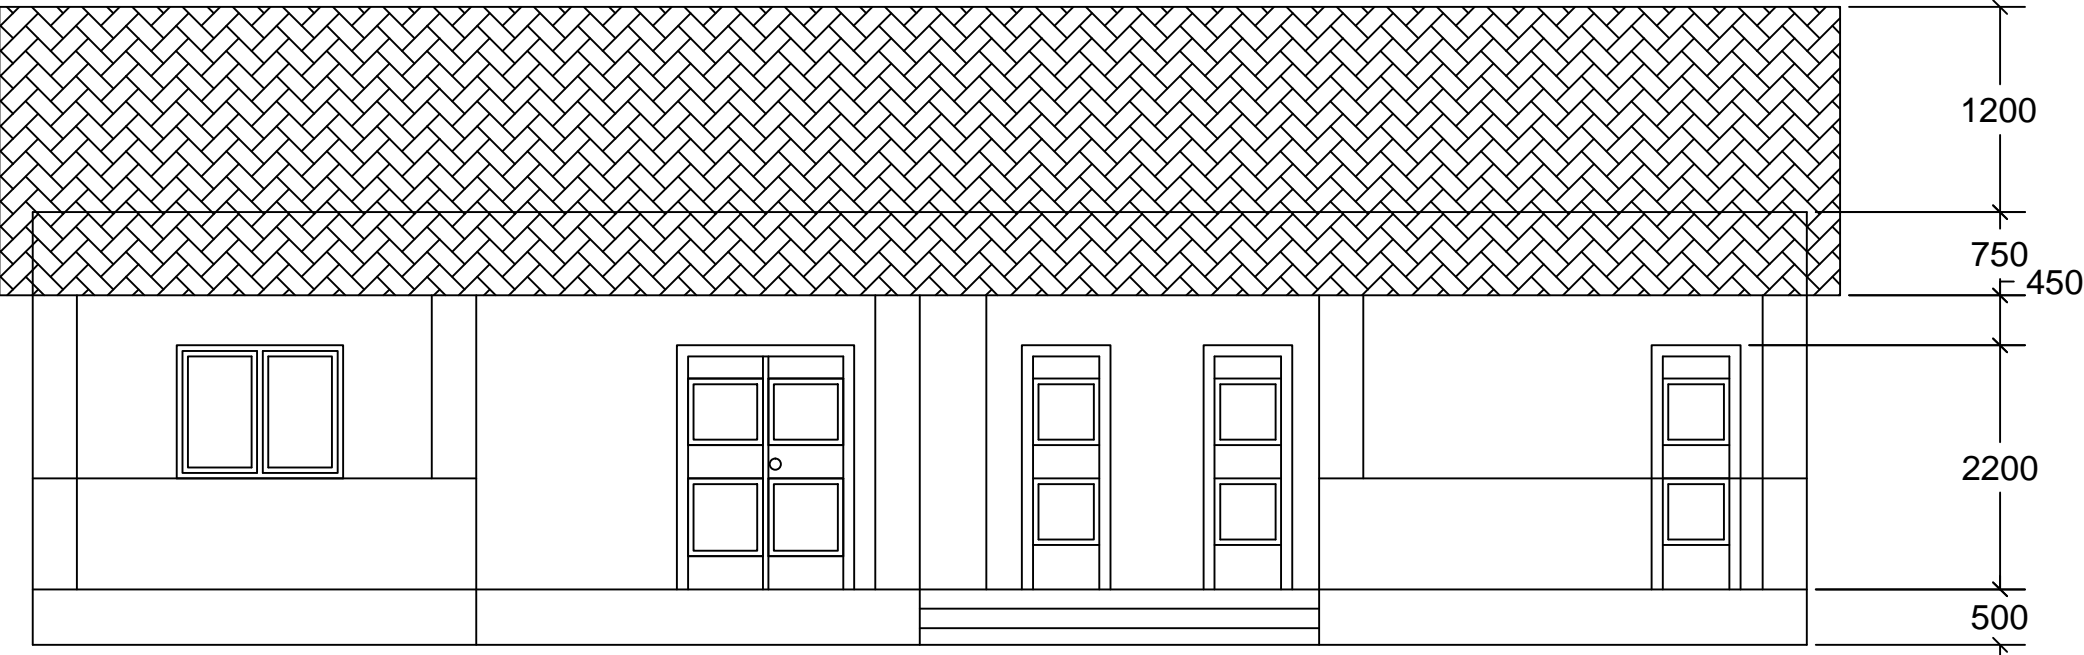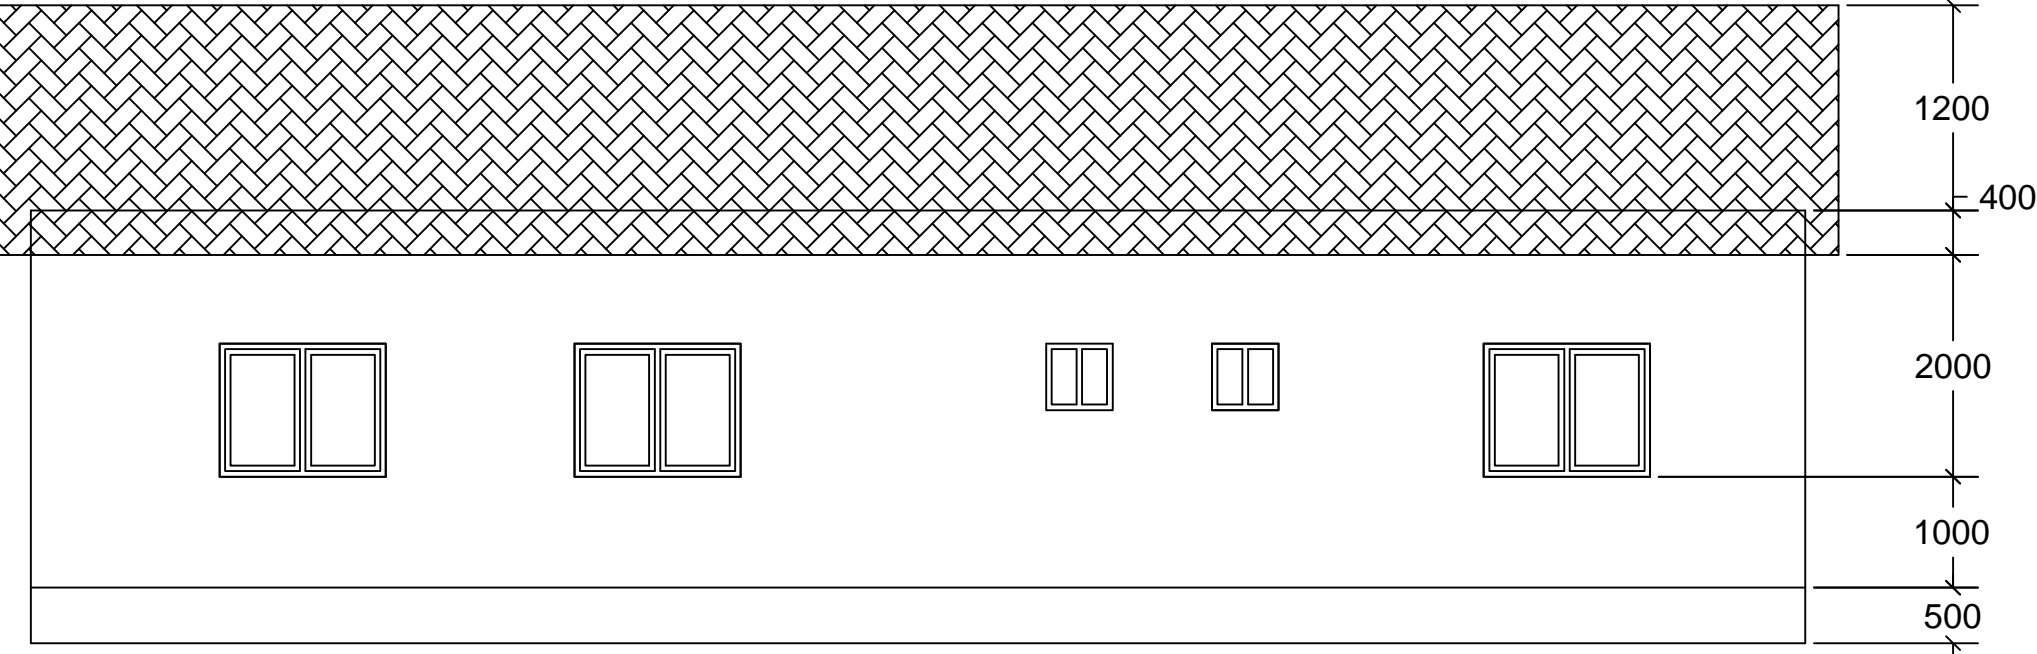

ELEVATION VIEW 01
Scale: 1:100

- Client:
1. All levels and dimensions to be checked on site before any building work commence
 - 2.All works to be strictly in accordance to with standard specification and notes
 3. walls below 200mm to be reinforced with hoop iron at every alternate course.
 4. This drawing is to be read in conjunction with specifications and all other relevant drawings

Client:	
Nis - Foundation	
project Name:	
Reconstruction of Lasanod hospital	
Drawing title:	
Drawing title:	
prepered by:	checked by:
XXXXXX	XXXXXX
Scale:	Date:
1:100	Feb - 2024
Drawing no:	Revision:
0001	

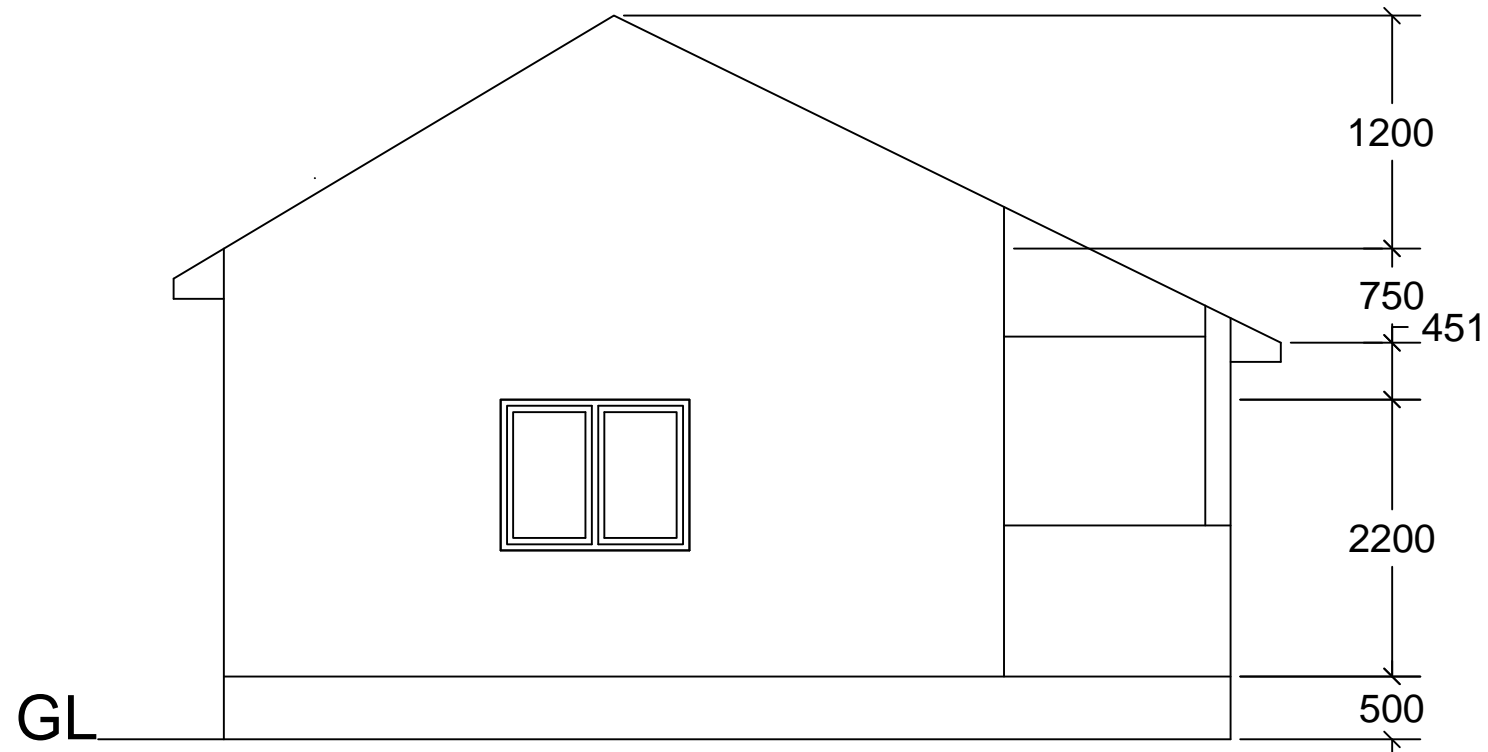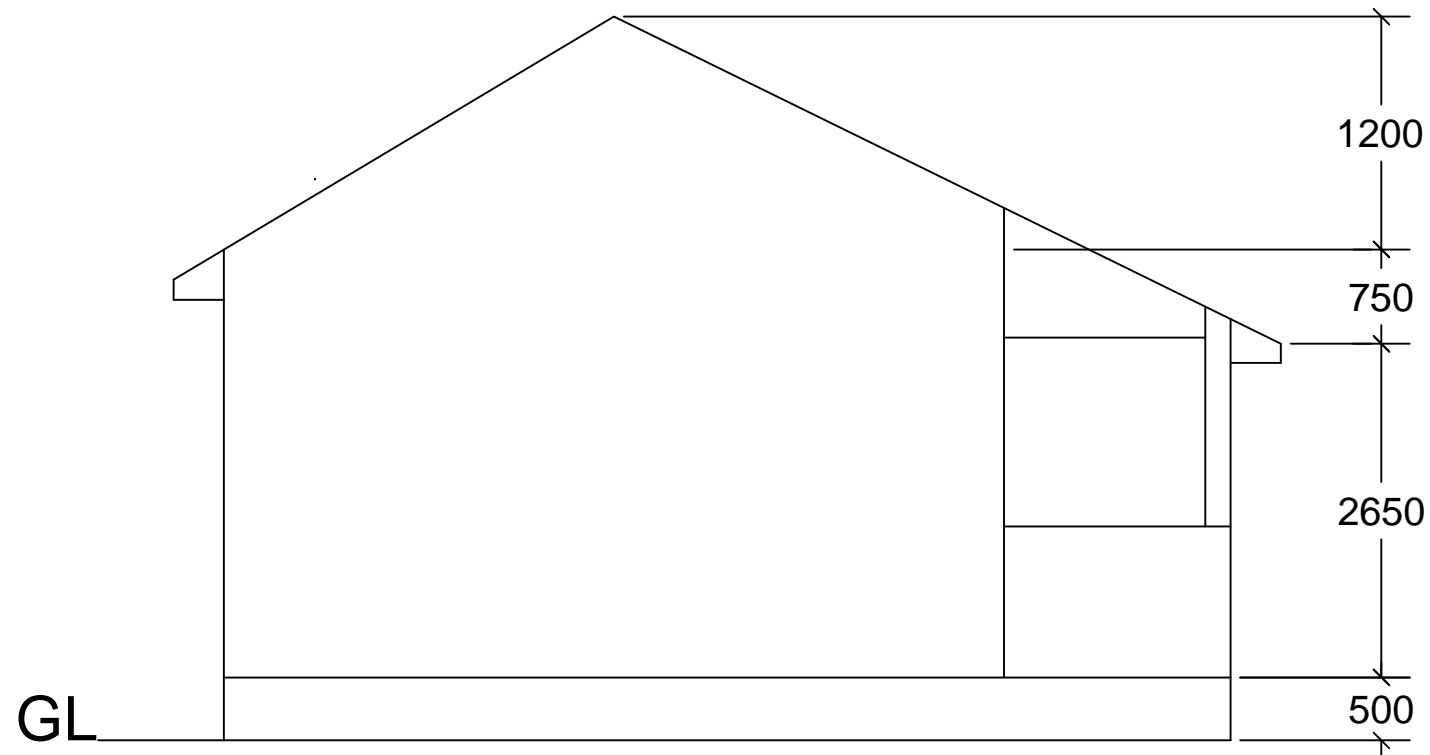

ELEVATION VIEW 02
Scale: 1:100

Client:

1. All levels and dimensions to be checked on site before any building work commence
- 2.All works to be strictly in accordance to with standard specification and notes
3. walls below 200mm to be reinforced with hoop iron at every alternate course.
4. This drawing is to be read in conjunction with specifications and all other relevant drawings

Client:

Nis - Foundation

project Name:

Reconstruction of Lasanod
hospital

Drawing title:

Drawing title:

prepered by:

XXXXXX

checked by:

XXXXXX

Scale:

1:100


Date:

Feb - 2024

Drawing no:


0001

Revision:

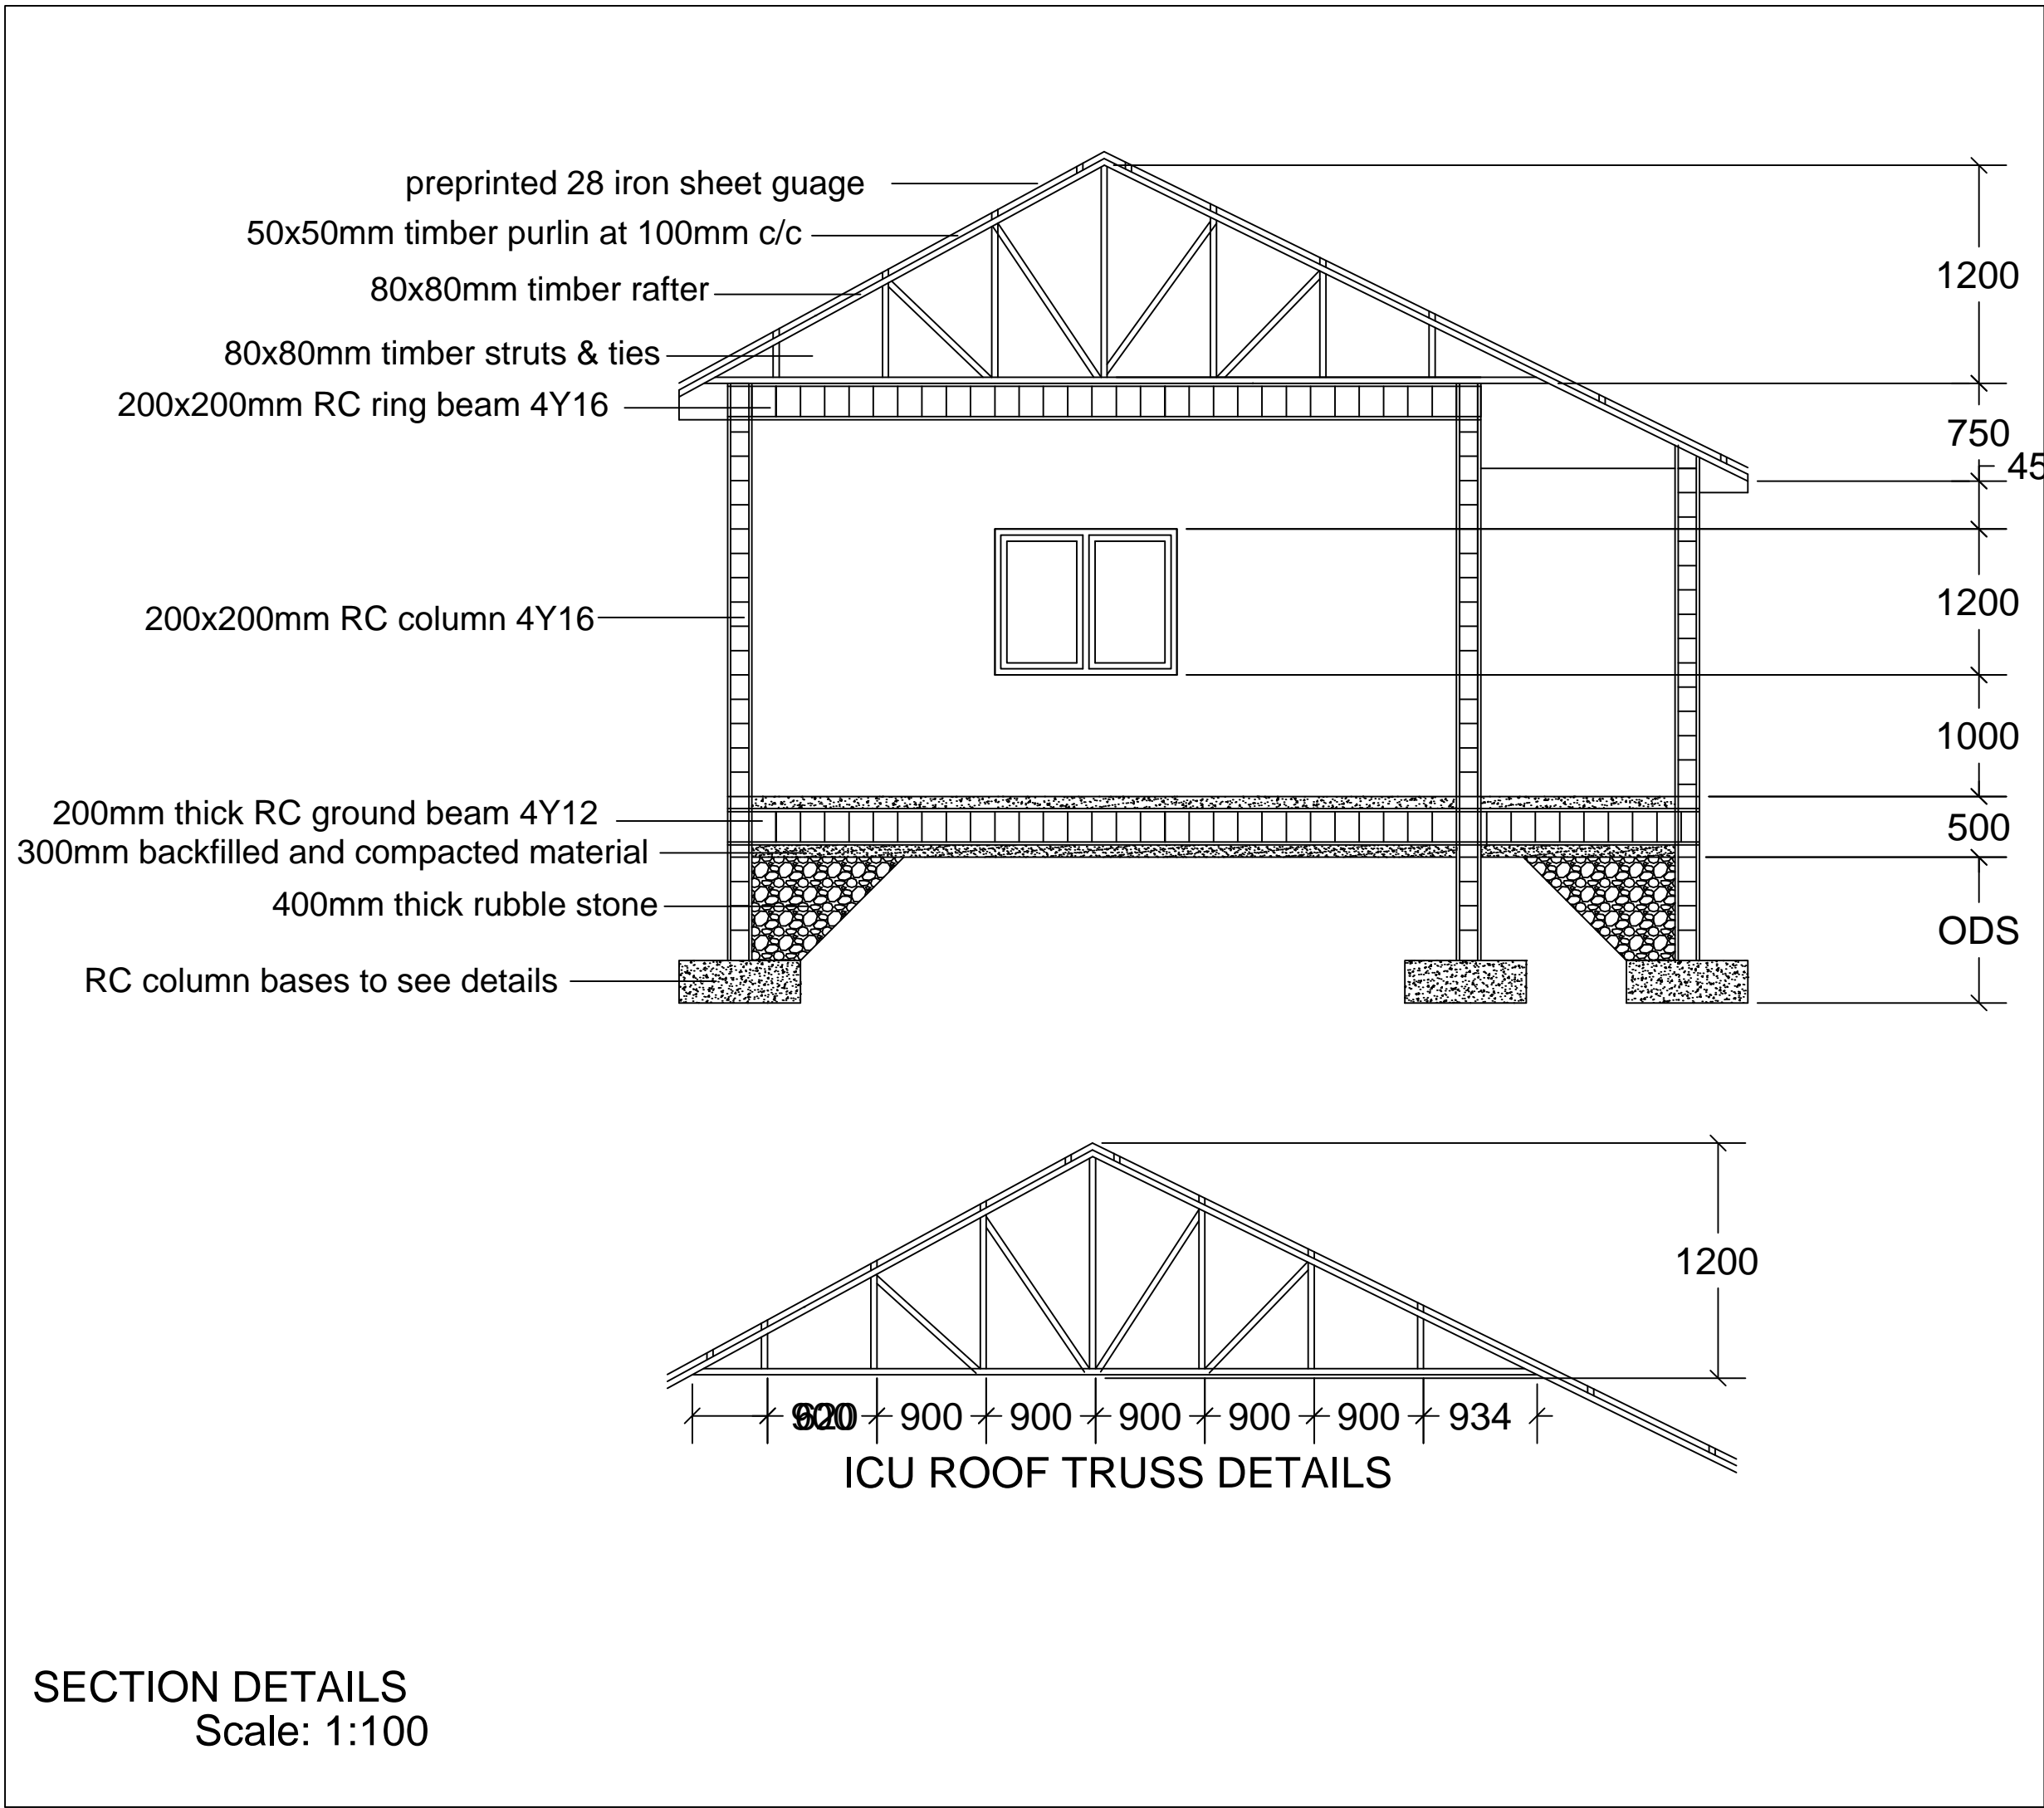

- Client:
1. All levels and dimensions to be checked on site before any building work commence
 - 2.All works to be strictly in accordance to with standard specification and notes
 3. walls below 200mm to be reinforced with hoop iron at every alternate course.
 4. This drawing is to be read in conjunction with specifications and all other relevant drawings


Client:	
Nis - Foundation	
project Name:	
Reconstruction of Lasanod hospital	
Drawing title:	
Drawing title:	
prepered by:	checked by:
XXXXXX	XXXXXX
Scale:	Date:
1:100	Feb - 2024
Drawing no:	Revision:
0001	

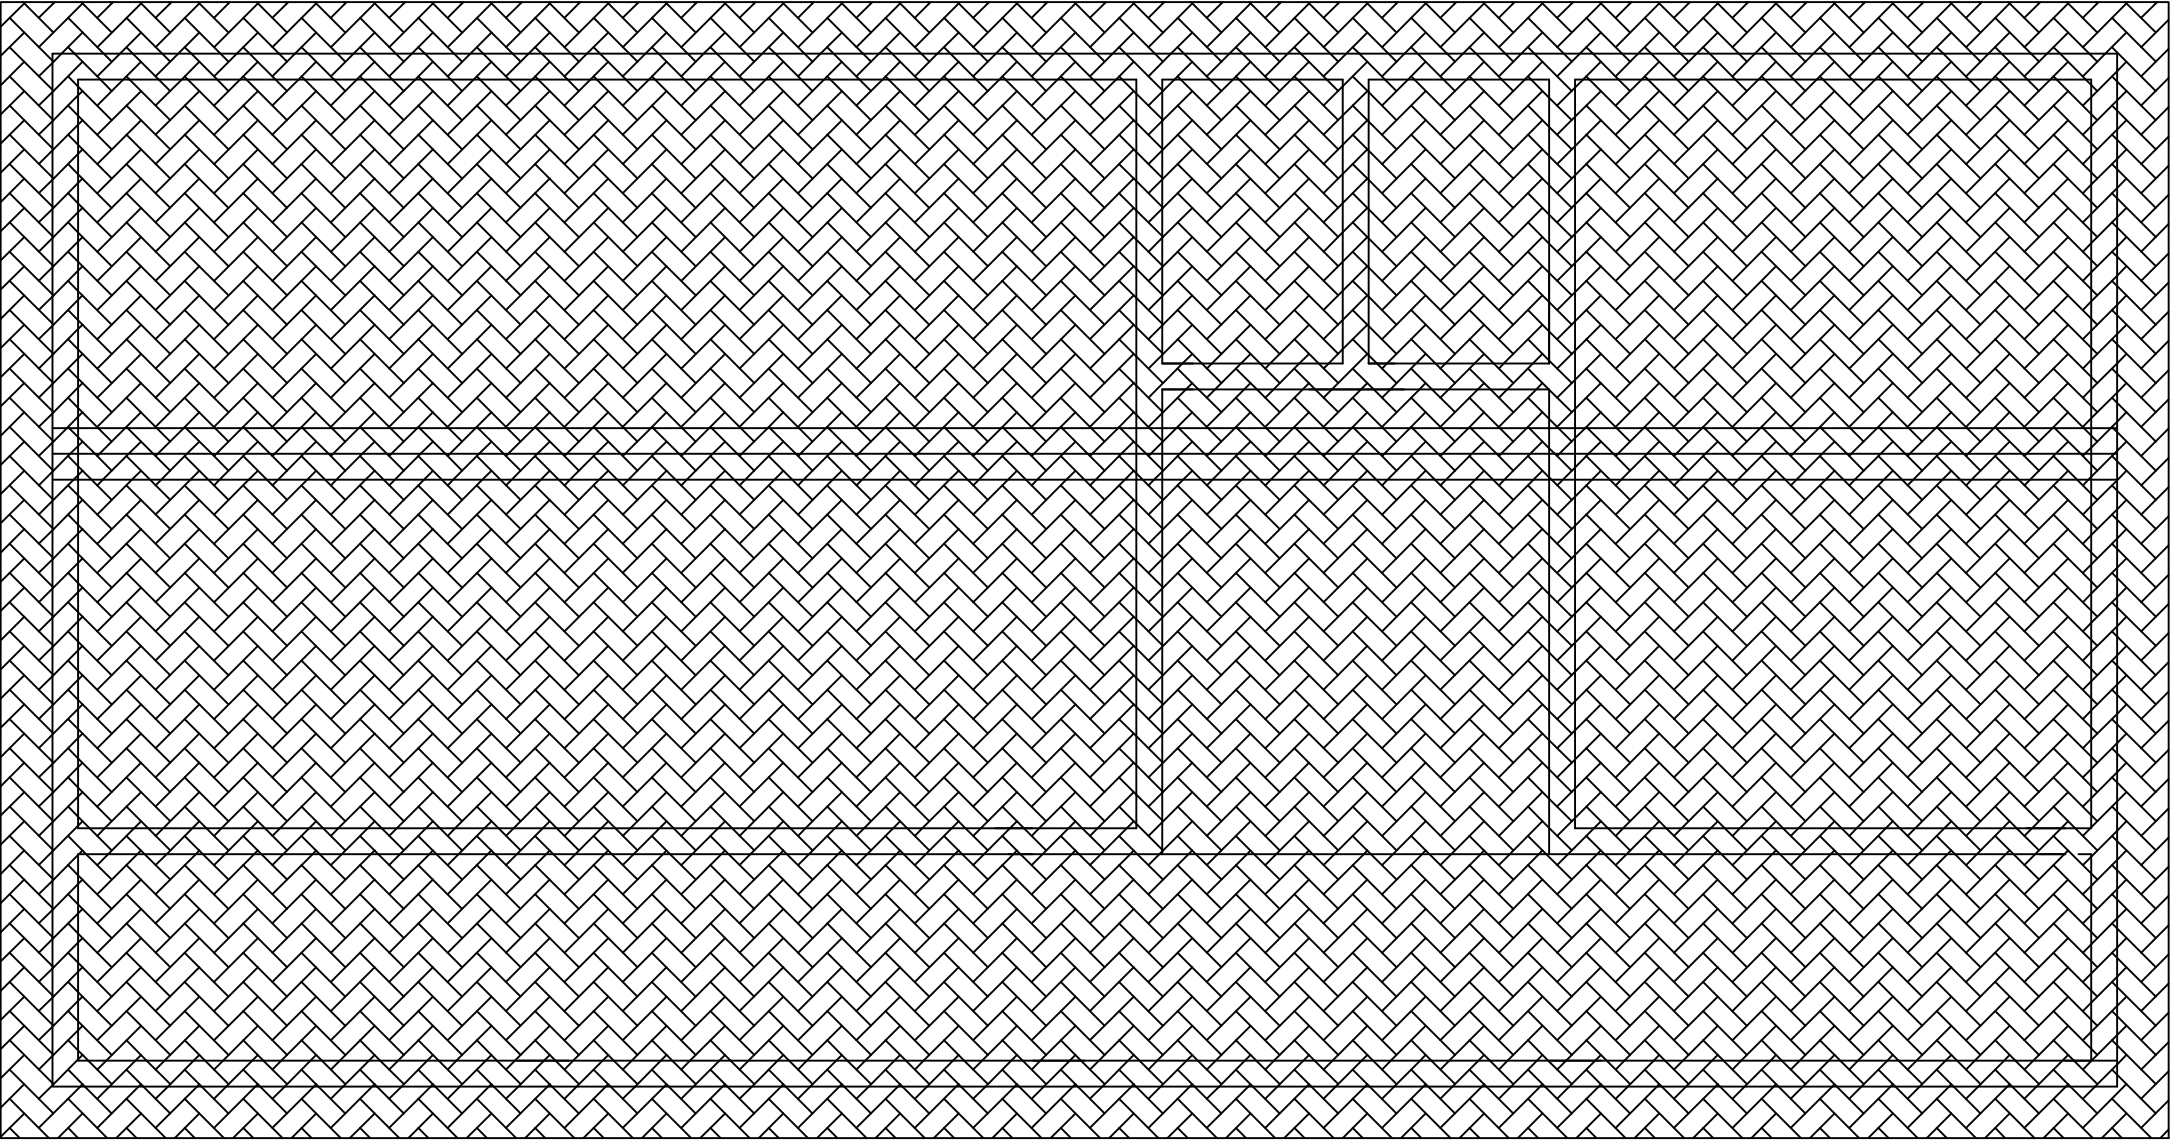

ROOF PLAN LAYOUT
Scale: 1:100

- Client:
- 1. All levels and dimensions to be checked on site before any building work commence
 - 2.All works to be strictly in accordance to with standard specification and notes
 - 3. walls below 200mm to be reinforced with hoop iron at every alternate course.
 - 4. This drawing is to be read in conjunction with specifications and all other relevant drawings


Client:	
Nis - Foundation	
project Name:	
Reconstruction of Lasanod hospital	
Drawing title:	
Drawing title:	
prepered by:	checked by:
XXXXXX	XXXXXX
Scale:	Date:
1:100	Feb - 2024
Drawing no:	Revision:
0001	

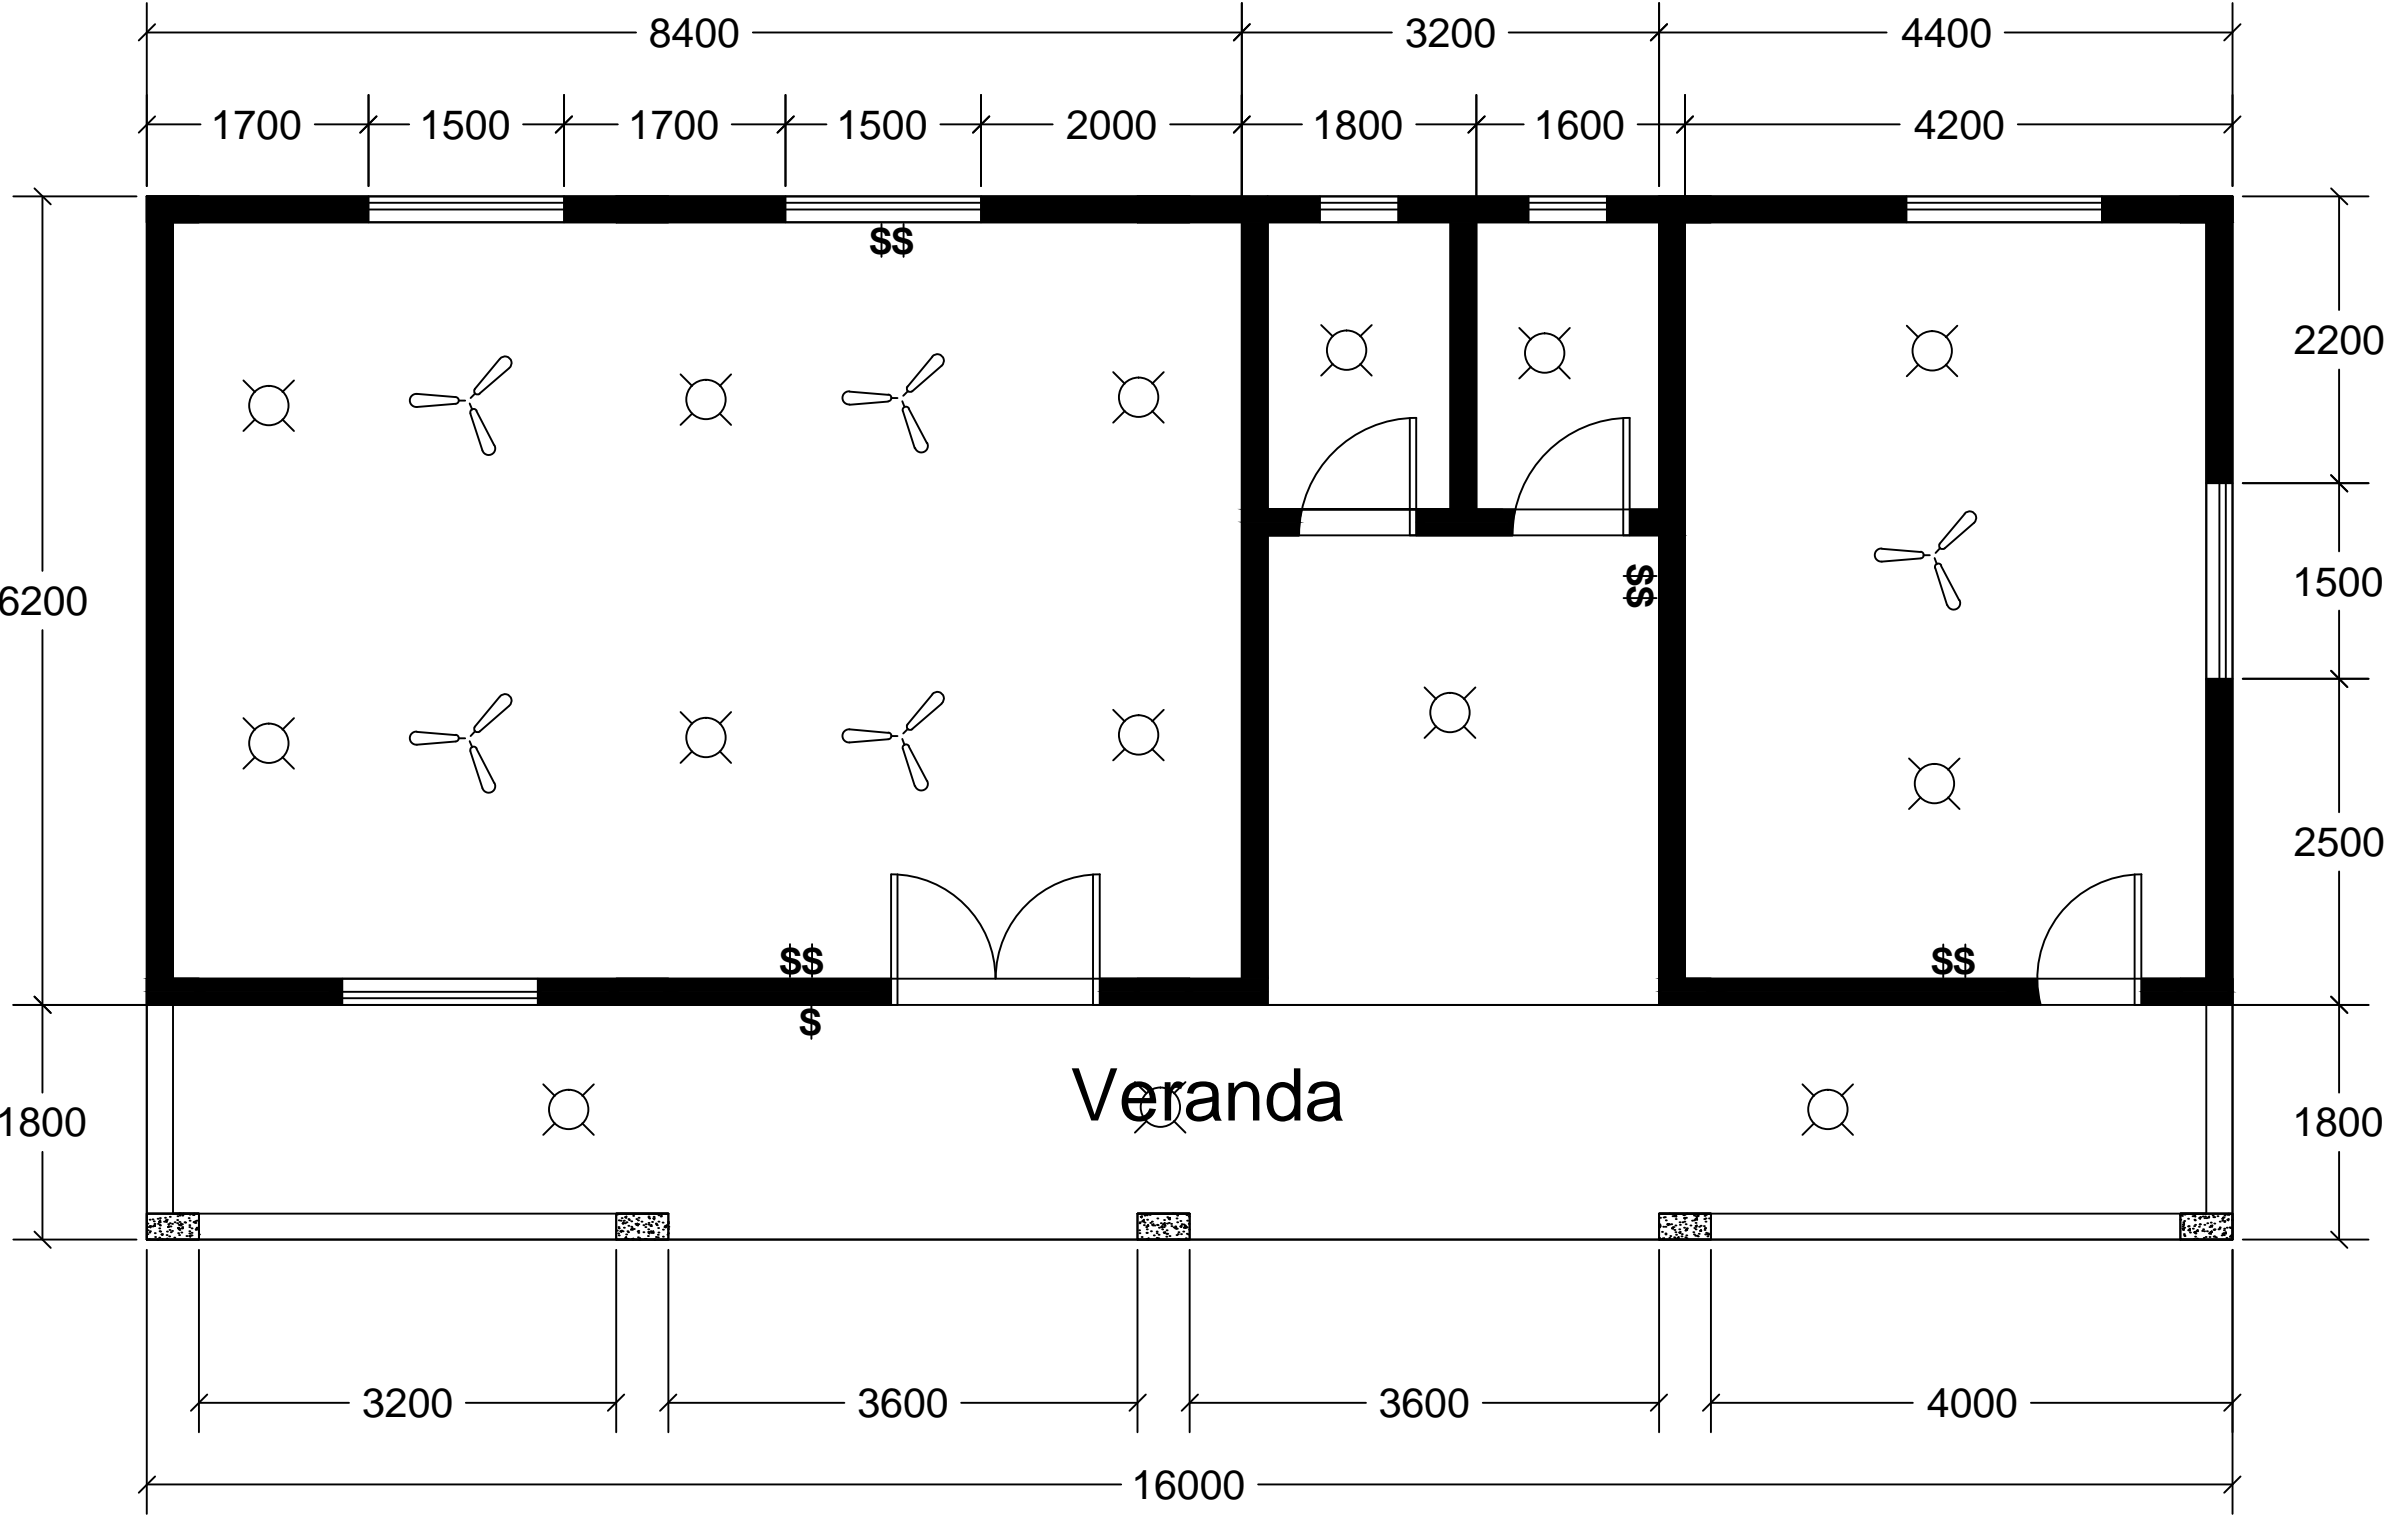

ELECTRIC PLAN LAYOUT
Scale: 1:100

- Client:
1. All levels and dimensions to be checked on site before any building work commence
 - 2.All works to be strictly in accordance to with standard specification and notes
 3. walls below 200mm to be reinforced with hoop iron at every alternate course.
 4. This drawing is to be read in conjunction with specifications and all other relevant drawings


Client:	
Nis - Foundation	
project Name:	
Reconstruction of Lasanod hospital	
Drawing title:	
Drawing title:	
prepered by:	checked by:
XXXXXX	XXXXXX
Scale:	Date:
1:100	Feb - 2024
Drawing no:	Revision:
0001	

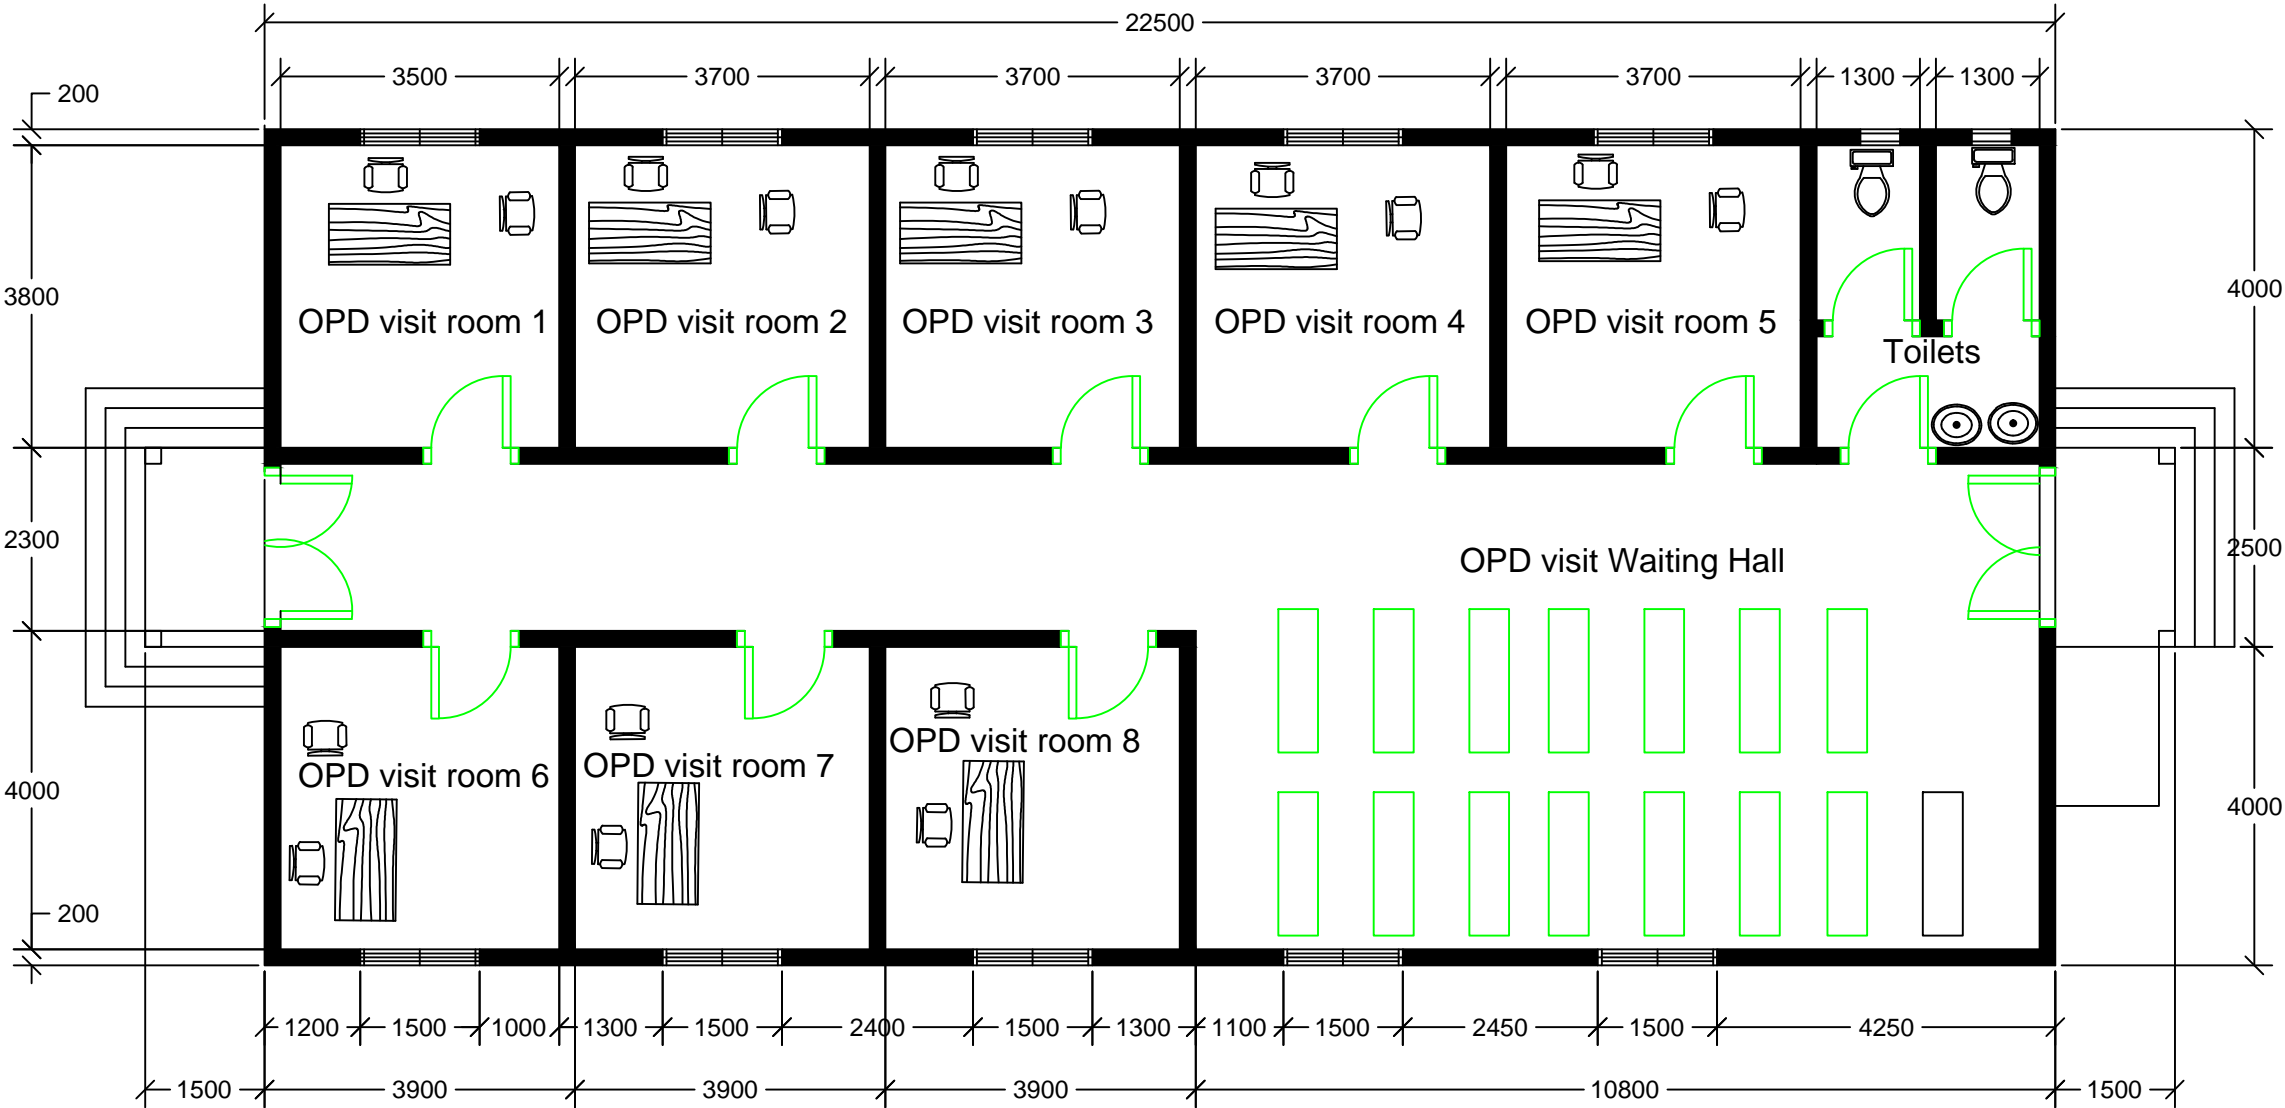

FLOOR PLAN LAYOUT OPD
SCALE: 1:100


- Client:**
- 1. All levels and dimensions to be checked on site before any building work commence
 - 2.All works to be strictly in accordance to with standard specification and notes
 - 3. walls below 200mm to be reinforced with hoop iron at every alternate course.
 - 4. This drawing is to be read in conjunction with specifications and all other relevant drawings

Client:	
Nis - Foundation	
project Name:	
Reconstruction of Lasanod hospital	
Drawing title:	
Drawing title:	
prepered by: XXXXXX	checked by: XXXXXX
Scale: 1:100	Date: Feb - 2024
Drawing no: 0001	Revision:

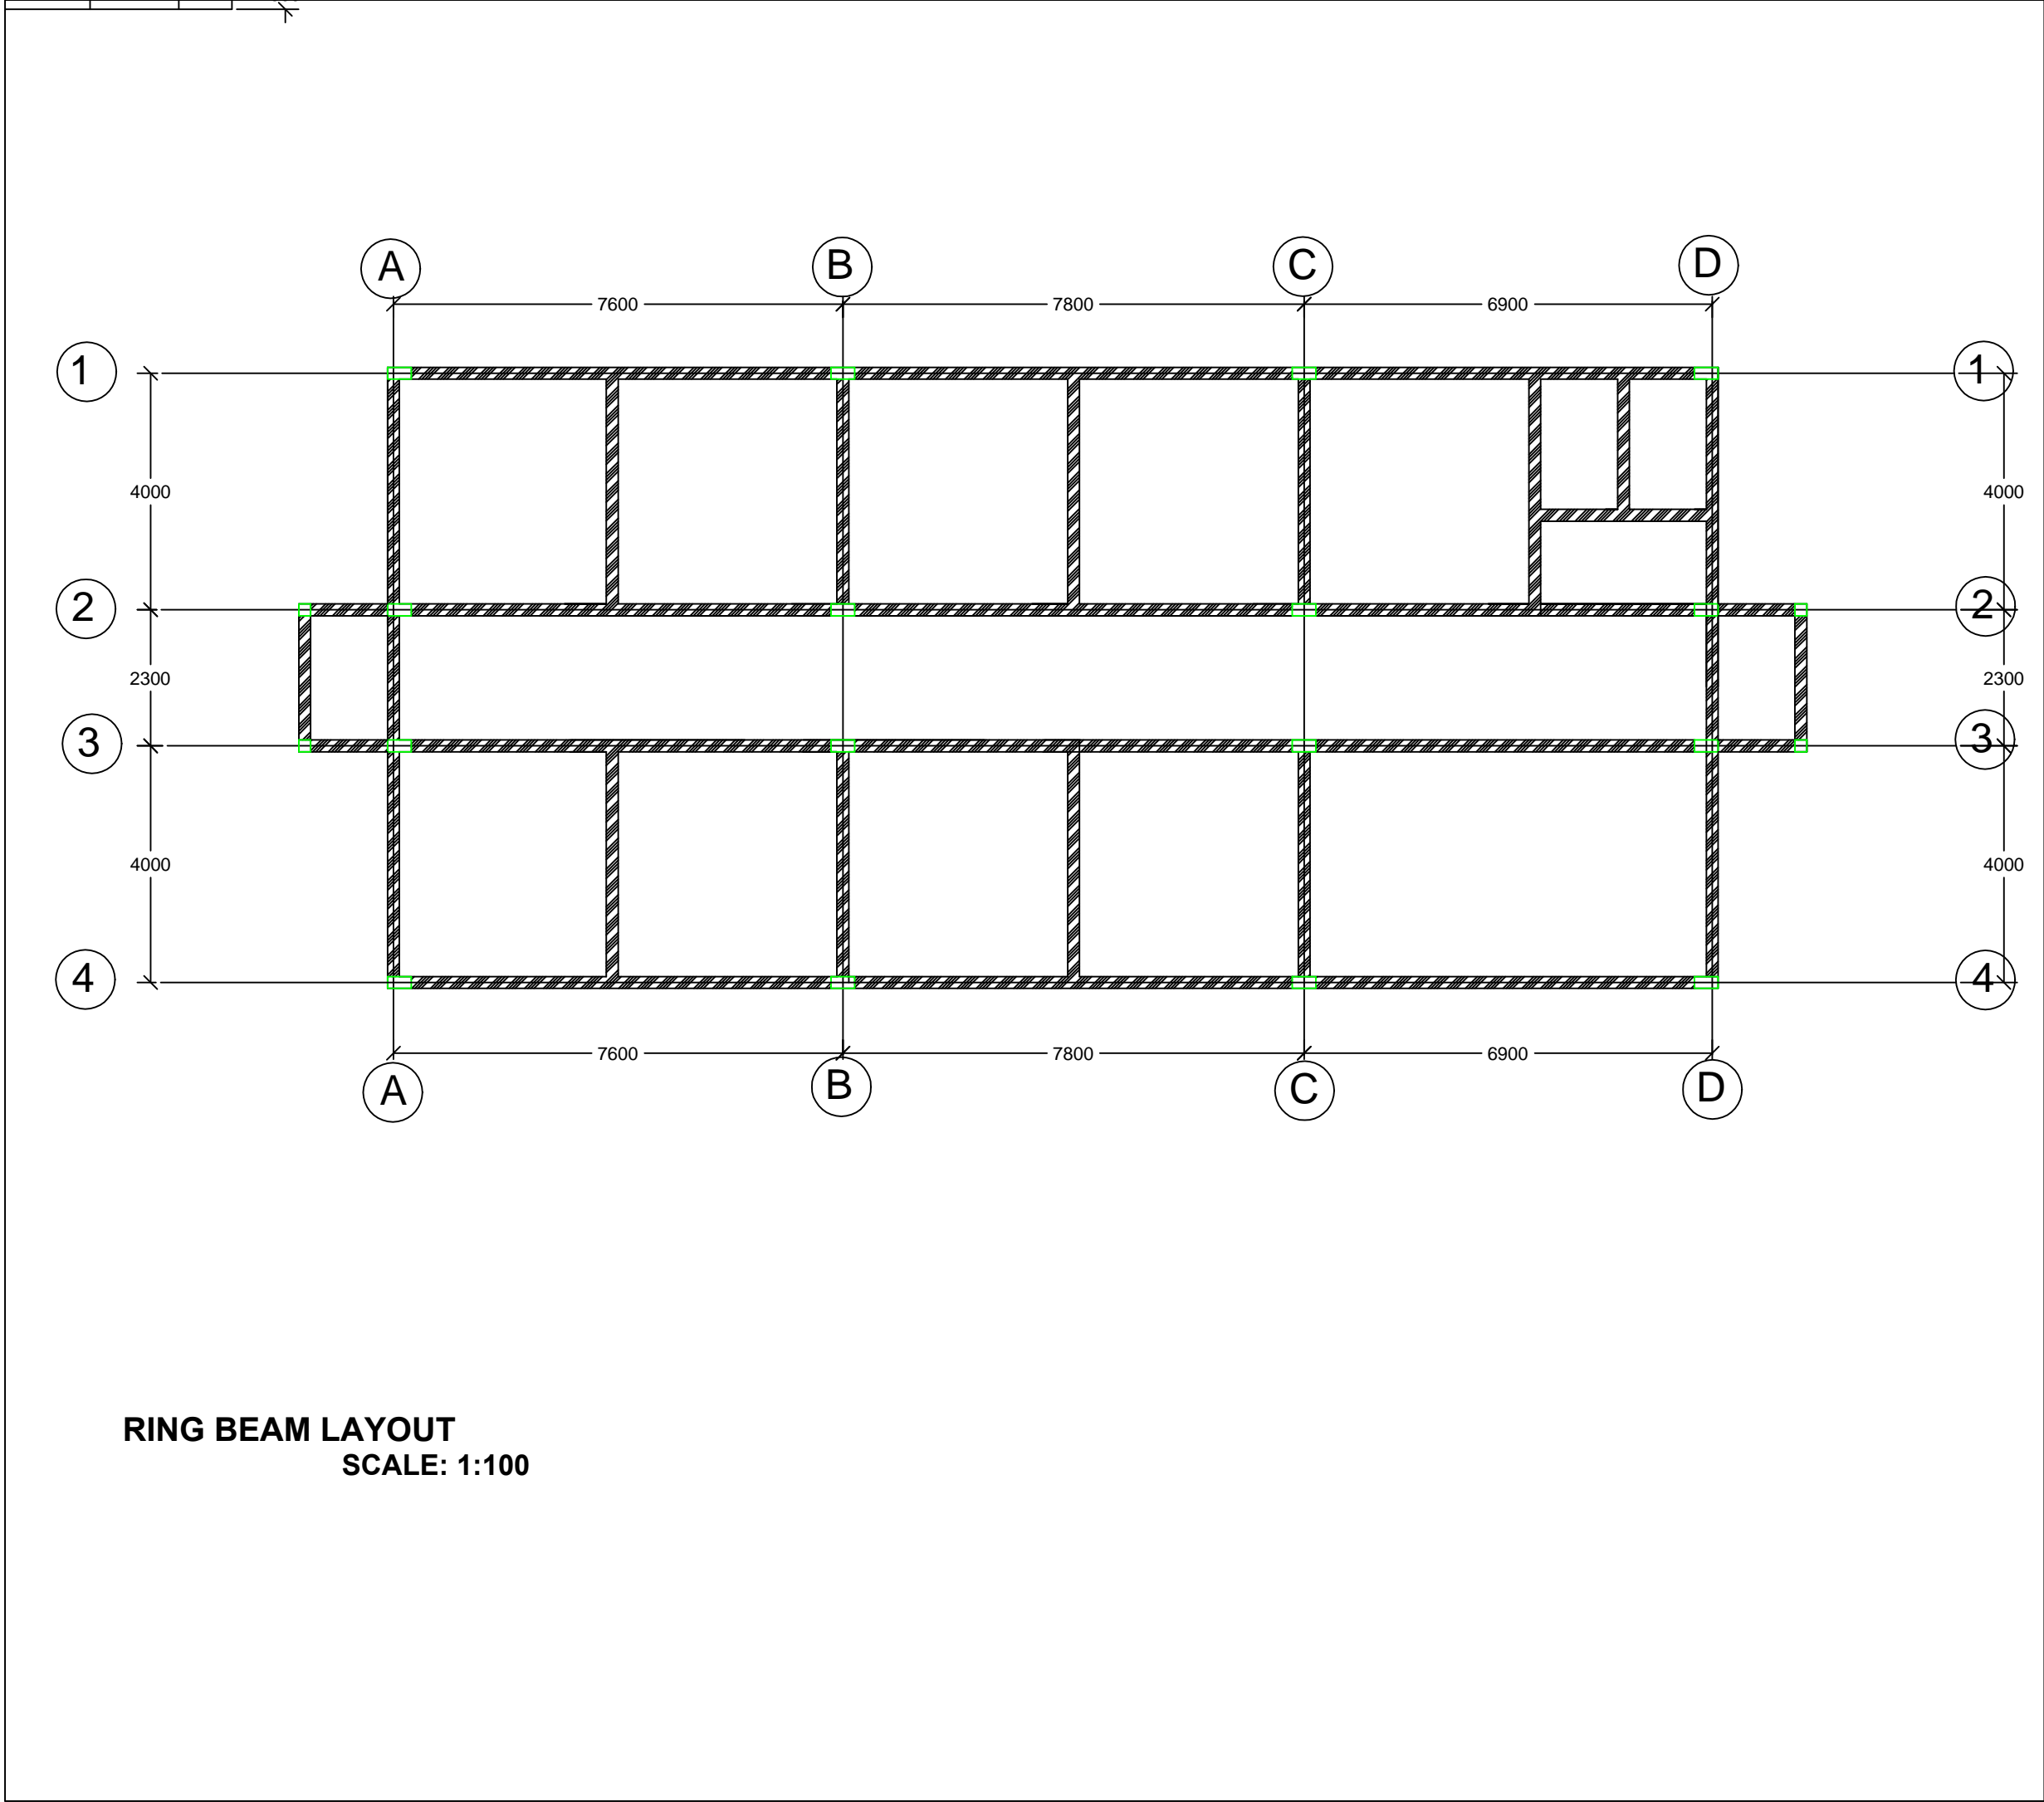

- Client:**
- 1. All levels and dimensions to be checked on site before any building work commence
 - 2.All works to be strictly in accordance to with standard specification and notes
 - 3. walls below 200mm to be reinforced with hoop iron at every alternate course.
 - 4. This drawing is to be read in conjunction with specifications and all other relevant drawings


Client:	
Nis - Foundation	
project Name:	
Reconstruction of Lasanod hospital	
Drawing title:	
Drawing title:	
prepered by: XXXXXX	checked by: XXXXXX
Scale: 1:100	Date: Feb - 2024
Drawing no: 0001	Revision:

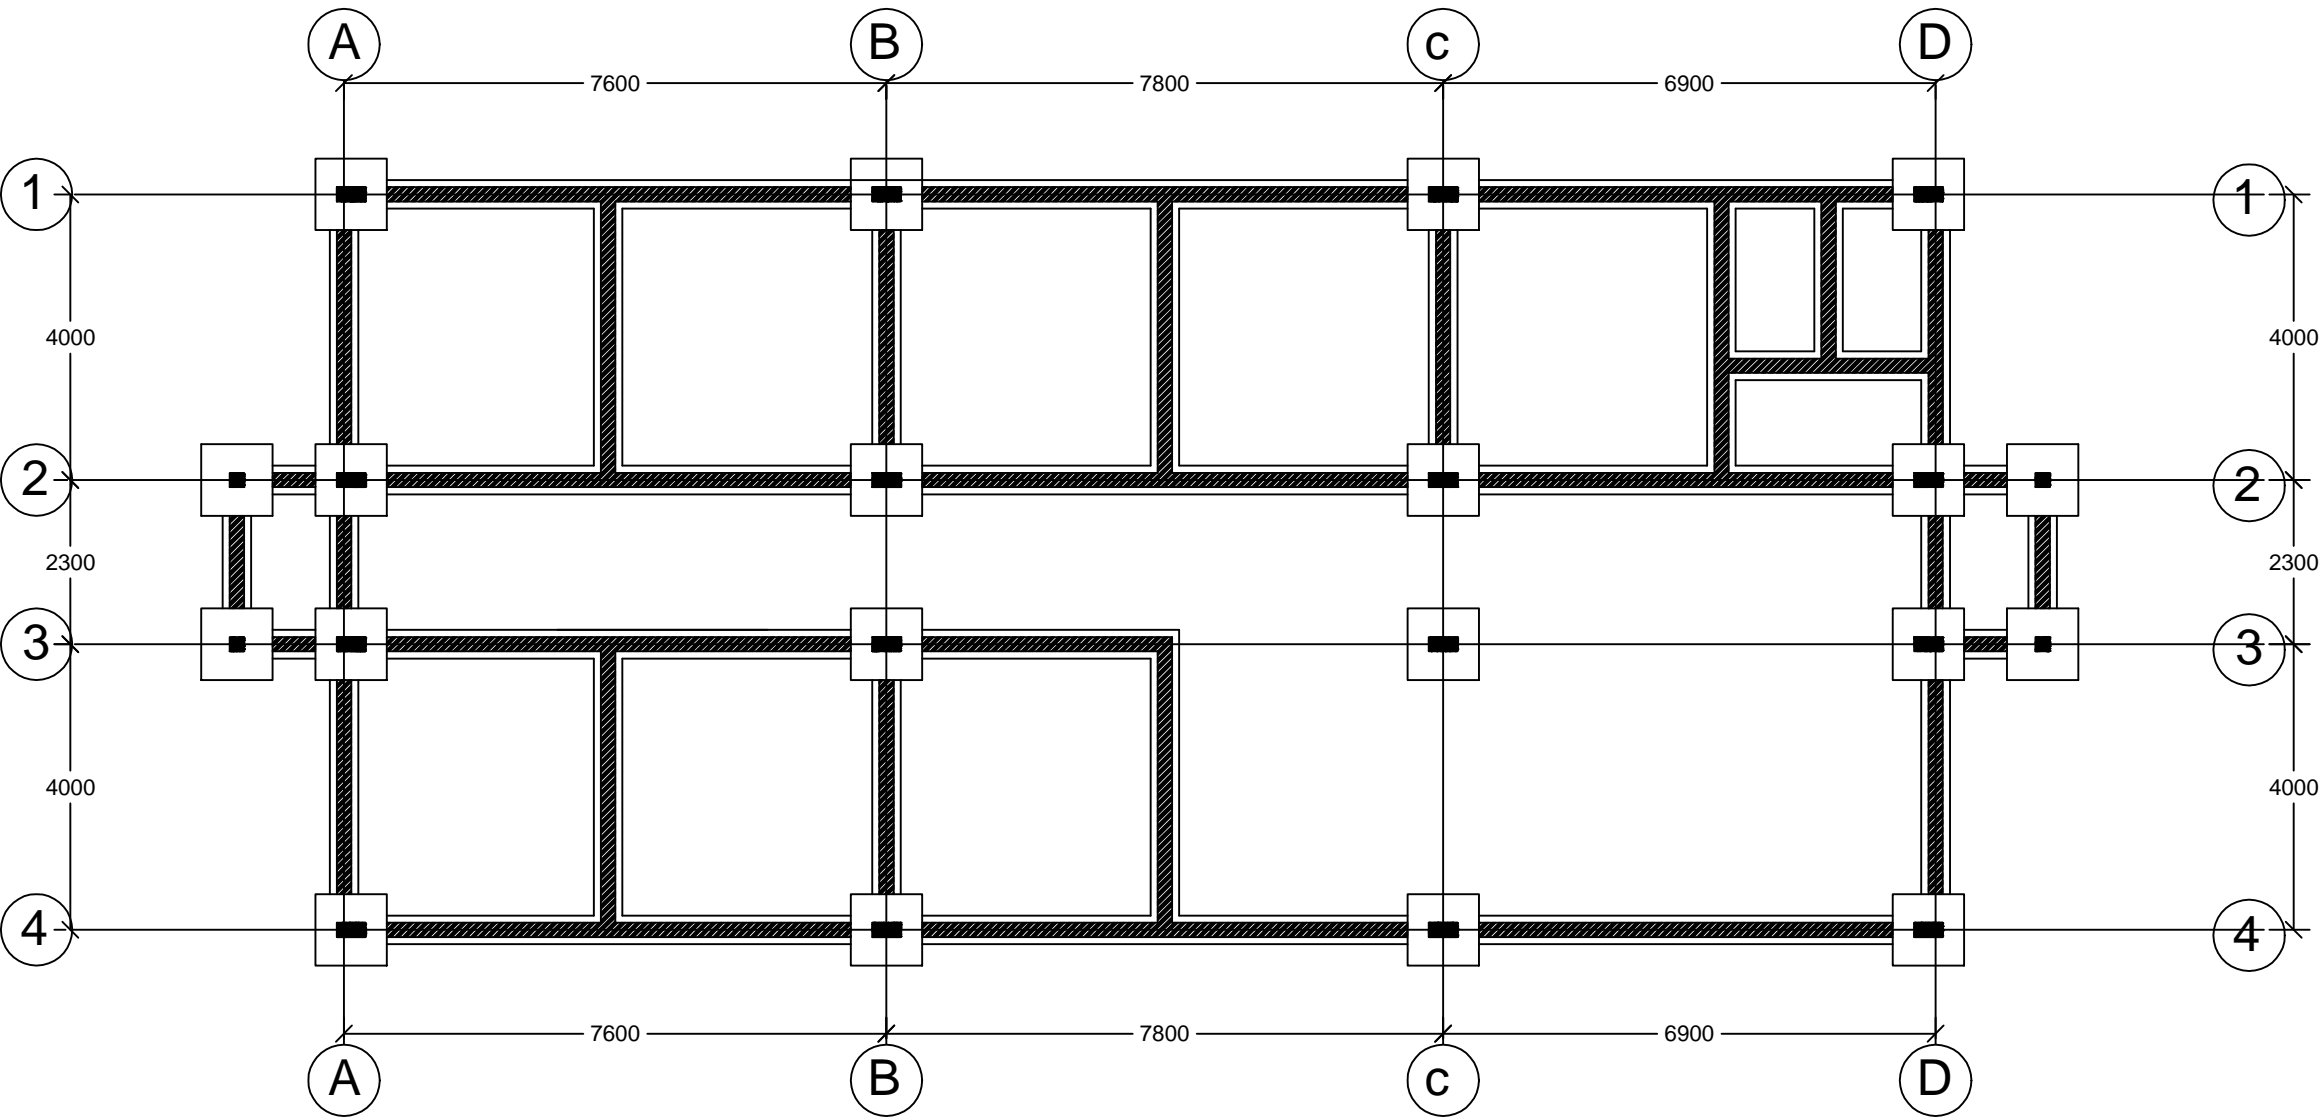



FOUNDATION LAYOUT
SCALE: 1:100

- Client:**
- 1. All levels and dimensions to be checked on site before any building work commance
 - 2.All works to be strictly in accordance to with standard specification and notes
 - 3. walls below 200mm to be reinforced with hoop iron at every alternate course.
 - 4. This drawing is to be read in conjunction with specifications and all other relevant drawings

Client:	
Nis - Foundation	
project Name:	
Reconstruction of Lasanod hospital	
Drawing title:	
Drawing title:	
prepered by: XXXXXX	checked by: XXXXXX
Scale: 1:100	Date: Feb - 2024
Drawing no: 0001	Revision:

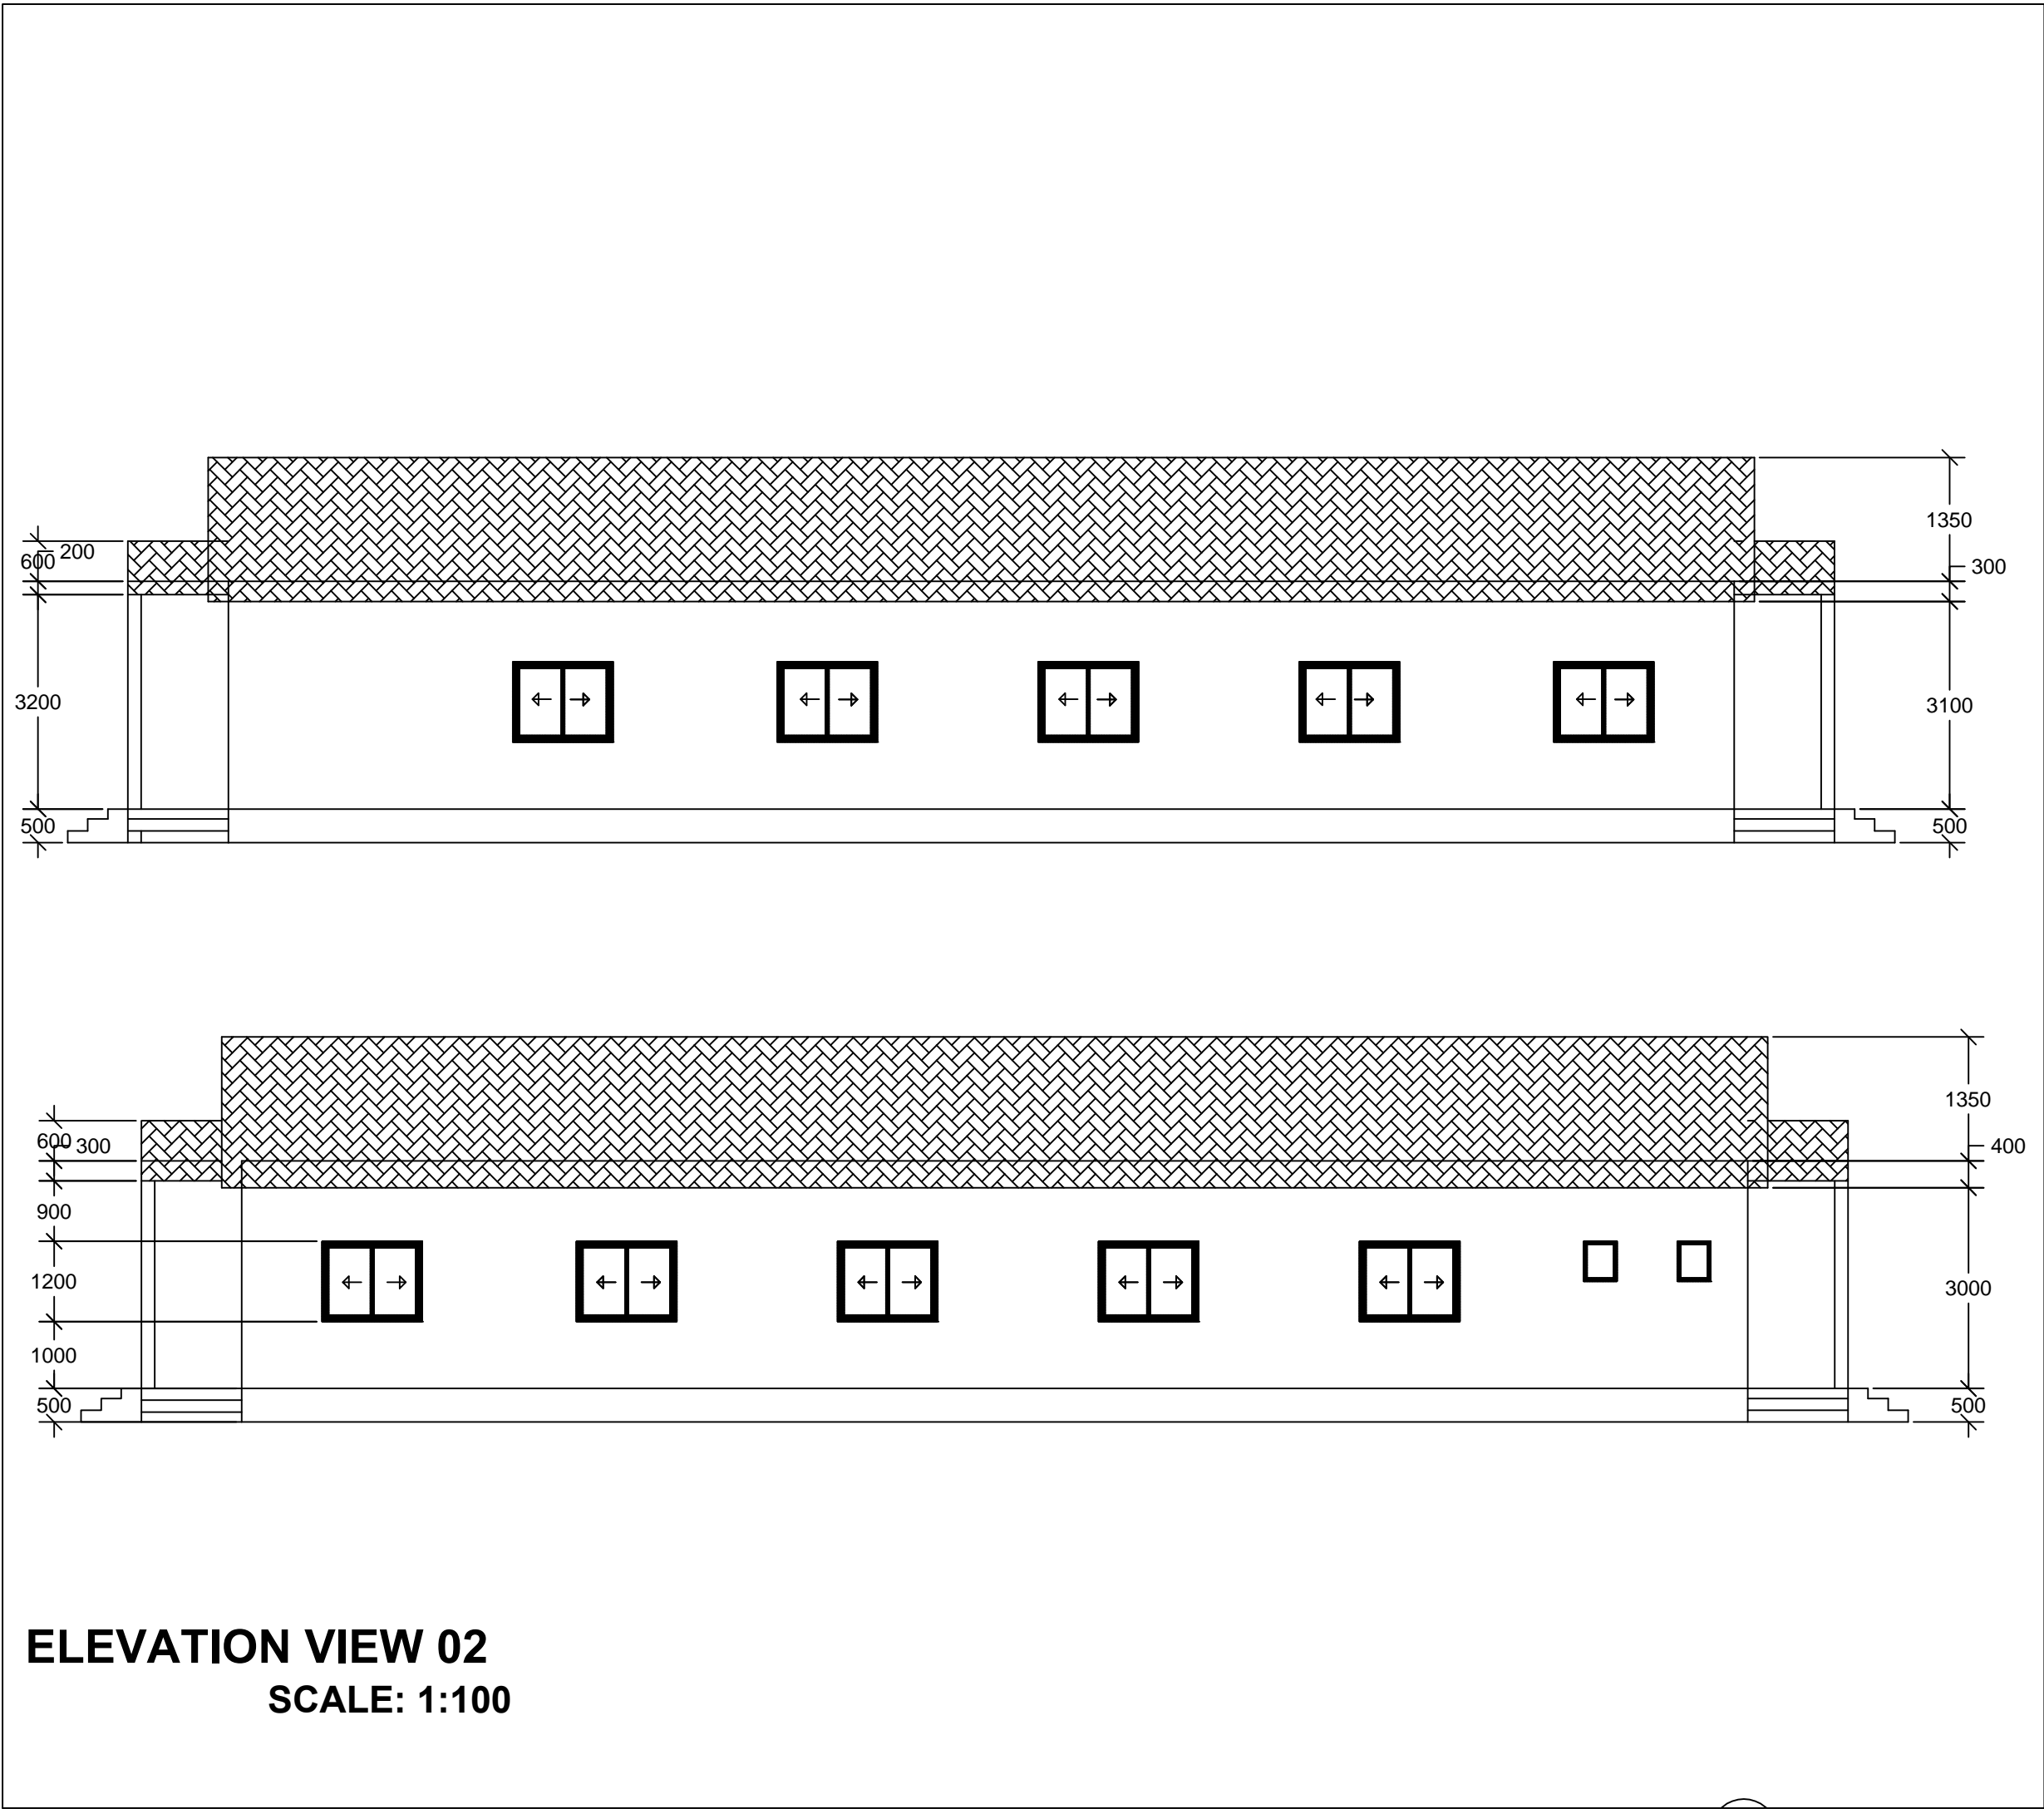

<div>Client:</div> <div><div>1. All levels and dimensions to be checked on site before any building work commence</div><div>2.All works to be strictly in accordance to with standard specification and notes</div><div>3. walls below 200mm to be reinforced with hoop iron at every alternate course.</div><div>4. This drawing is to be read in conjunction with specifications and all other relevant drawings</div></div>	
<div>Client:</div> <div>Nis - Foundation</div>	
<div>project Name:</div> <div>Reconstruction of Lasanod hospital</div>	
<div>Drawing title:</div> <div>Drawing title:</div>	
<div>prepered by:</div> <div>XXXXXX</div>	<div>checked by:</div> <div>XXXXXX</div>
<div>Scale:</div> <div>1:100</div>	<div>Date:</div> <div>Feb - 2024</div>
<div>Drawing no:</div> <div>0001</div>	<div>Revision:</div> <div></div>

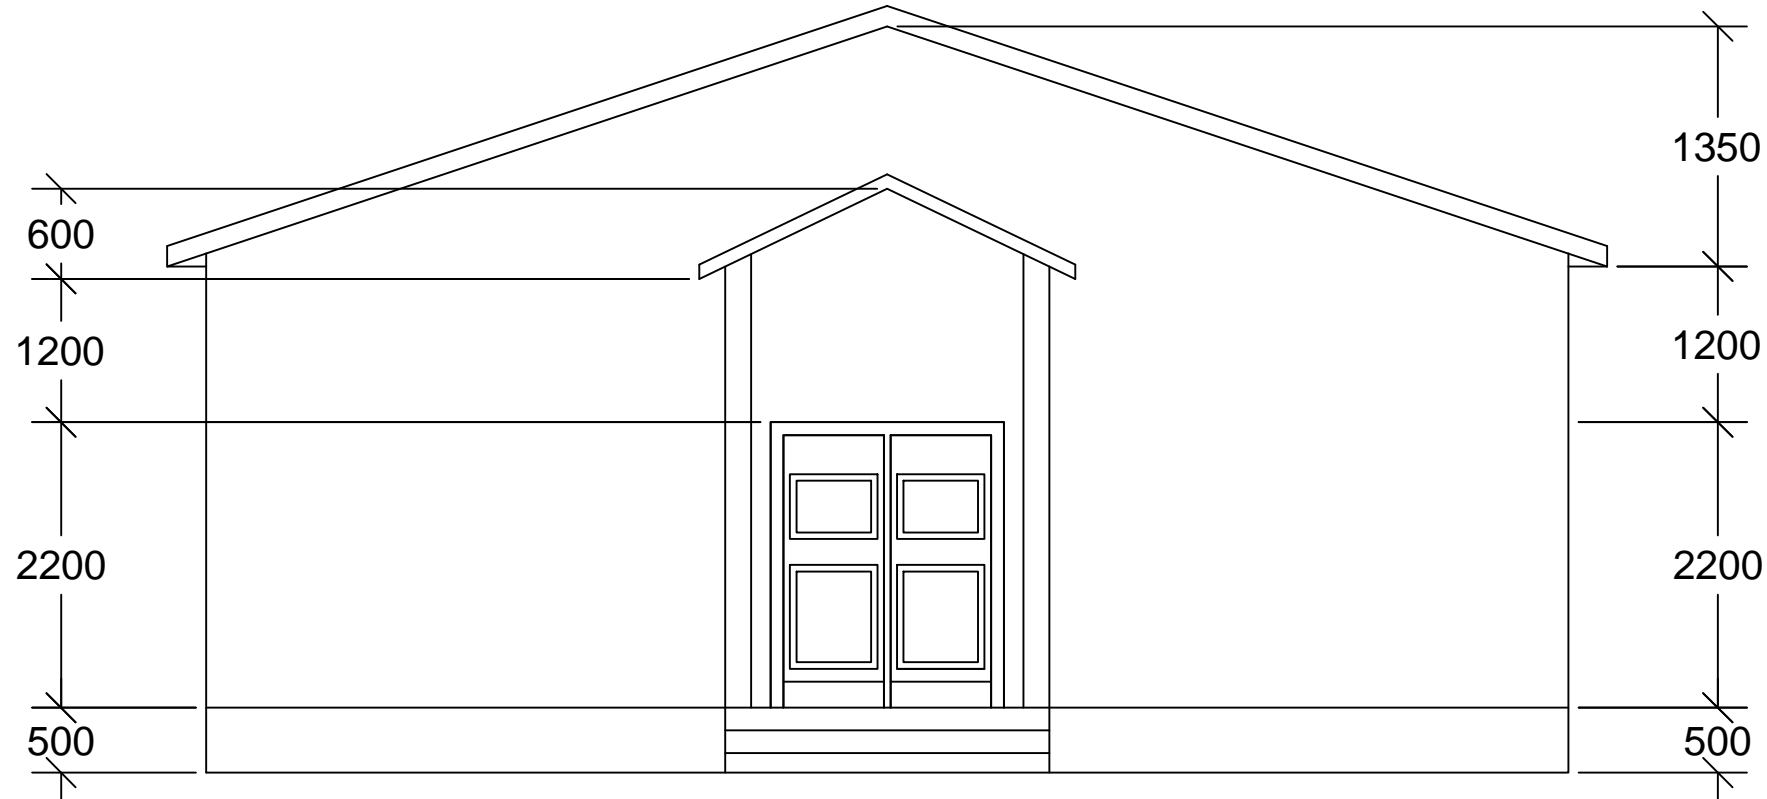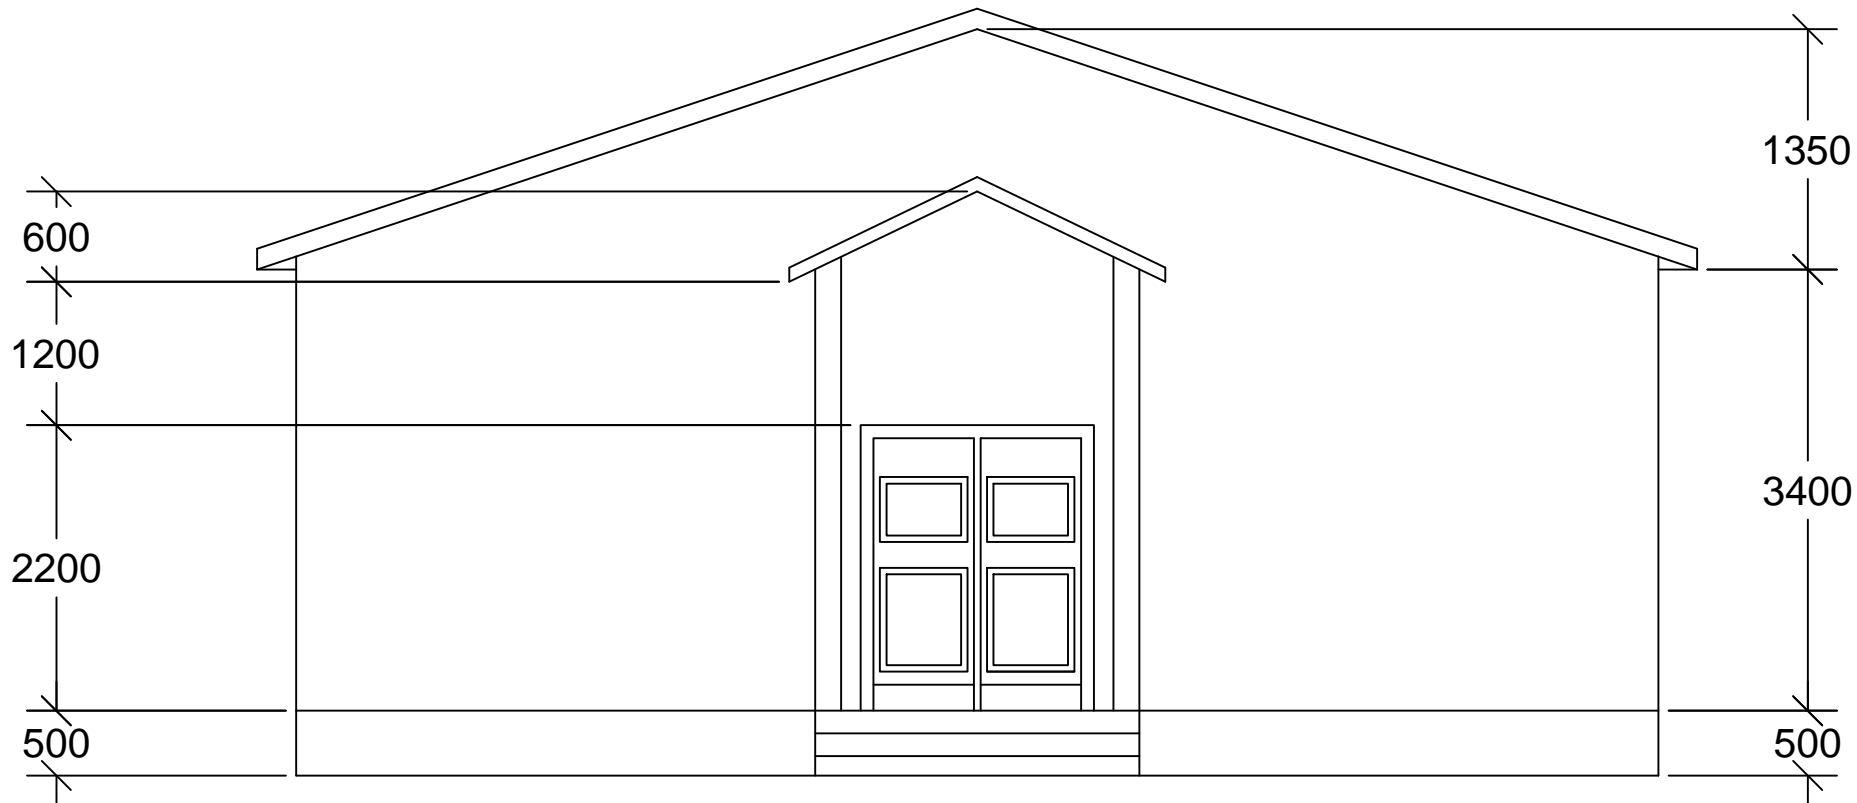

ELEVATION 01
SCALE: 1:100

<div>Client:</div> <div><div>1. All levels and dimensions to be checked on site before any building work commance</div><div>2.All works to be strictly in accordance to with standard specification and notes</div><div>3. walls below 200mm to be reinforced with hoop iron at every alternate course.</div><div>4. This drawing is to be read in conjunction with specifications and all other relevant drawings</div></div>	
<div>Client:</div> <div>Nis - Foundation</div>	
<div>project Name:</div> <div>Reconstruction of Lasanod hospital</div>	
<div>Drawing title:</div> <div>Drawing title:</div>	
<div>prepered by:</div> <div>XXXXXX</div>	<div>checked by:</div> <div>XXXXXX</div>
<div>Scale:</div> <div>1:100</div>	<div>Date:</div> <div>Feb - 2024</div>
<div>Drawing no:</div> <div>0001</div>	<div>Revision:</div> <div></div>



- Client:
1. All levels and dimensions to be checked on site before any building work commence

2.All works to be strictly in accordance to with standard specification and notes

3. walls below 200mm to be reinforced with hoop iron at every alternate course.


4. This drawing is to be read in conjunction with specifications and all other relevant drawings

Client:	
Nis - Foundation	
project Name:	
Reconstruction of Lasanod hospital	
Drawing title:	
Drawing title:	
prepered by:	checked by:
XXXXXX	XXXXXX
Scale:	Date:
1:100	Feb - 2024
Drawing no:	Revision:
0001	

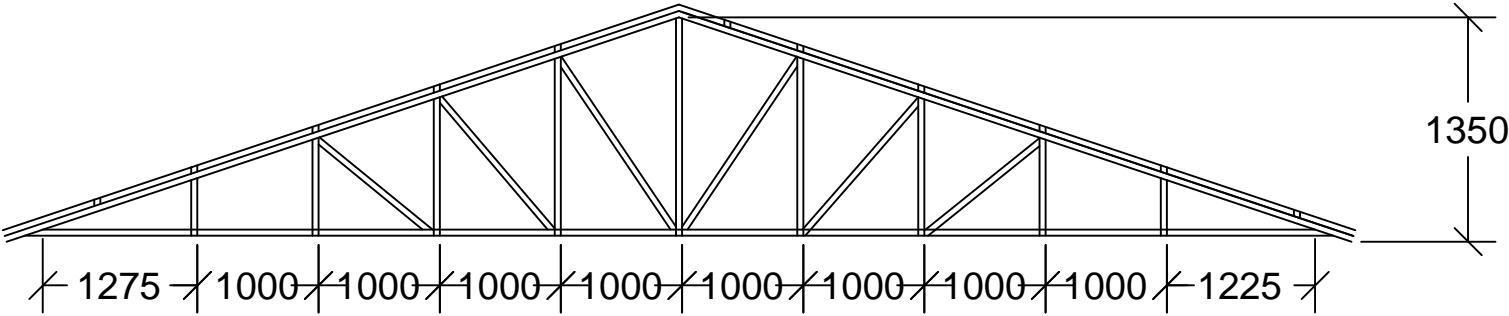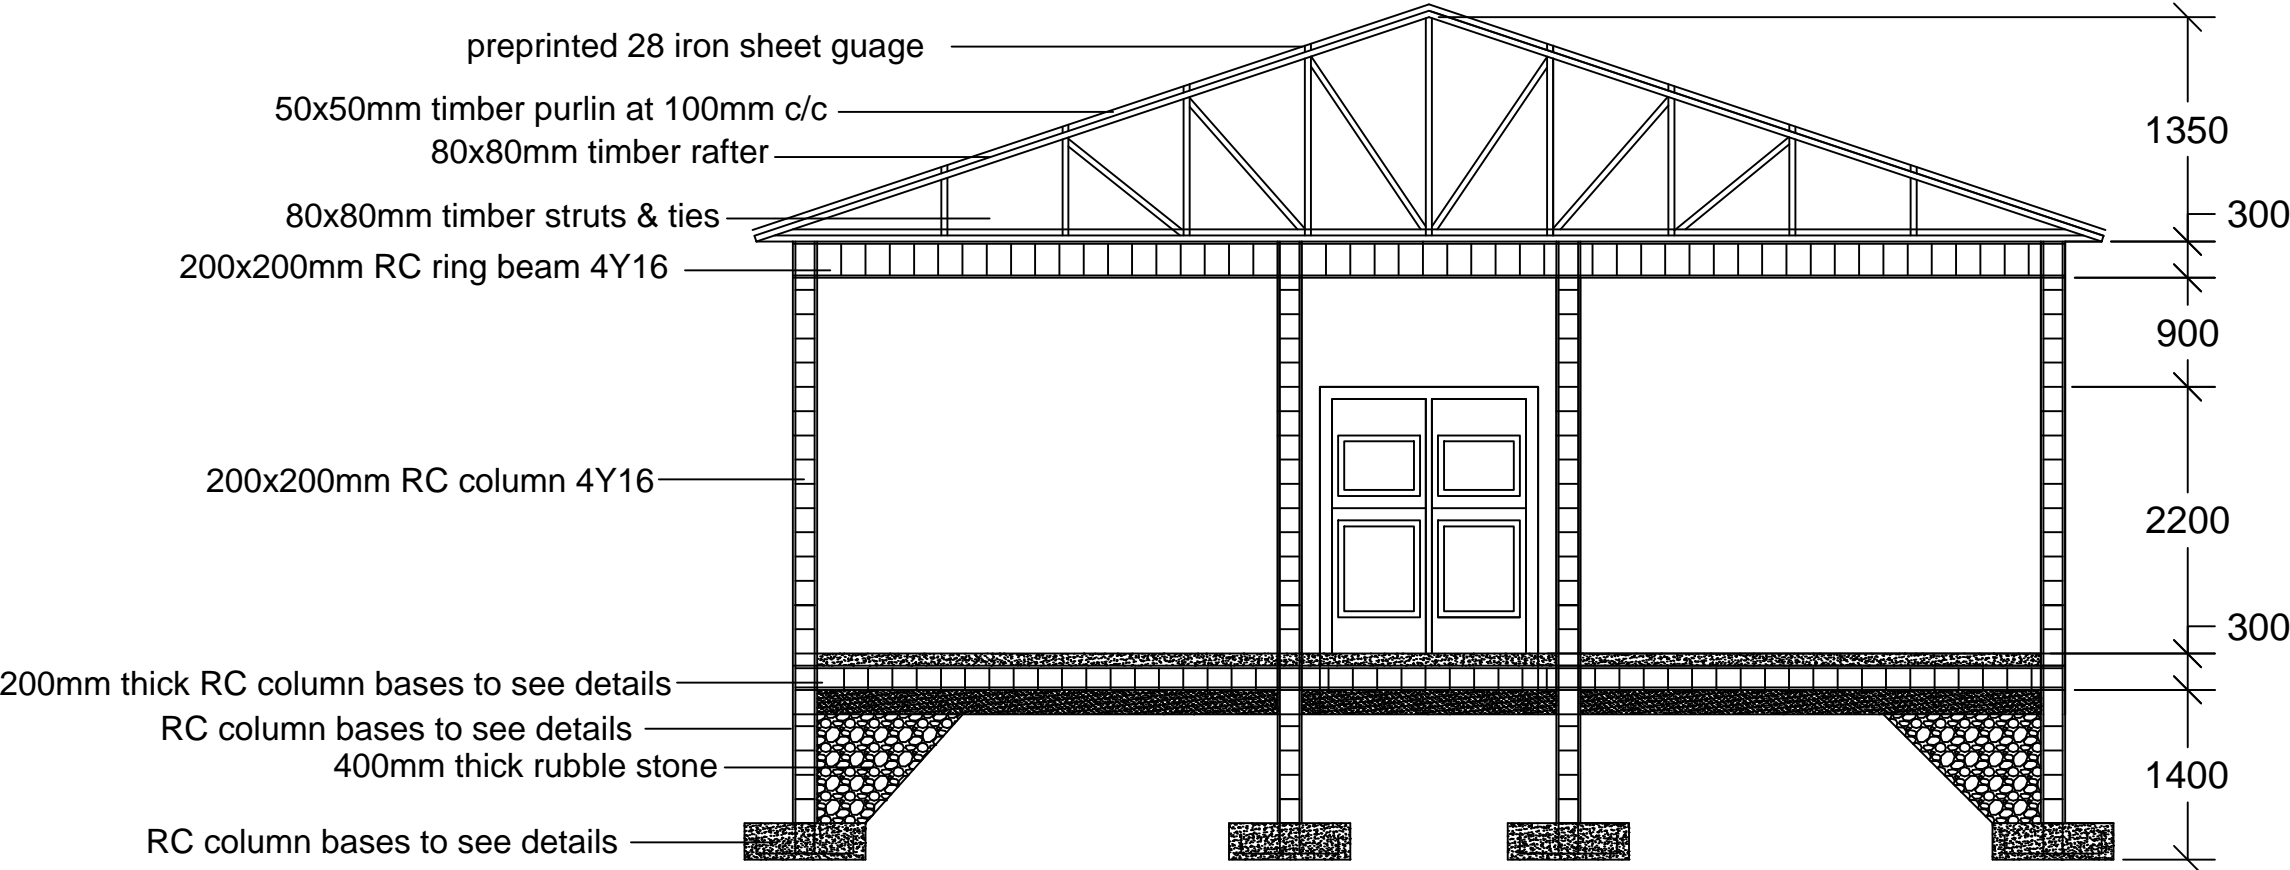

OPD ROOF TRUSS DETAILS


SECTIONDETAIL
Scale: 1:100

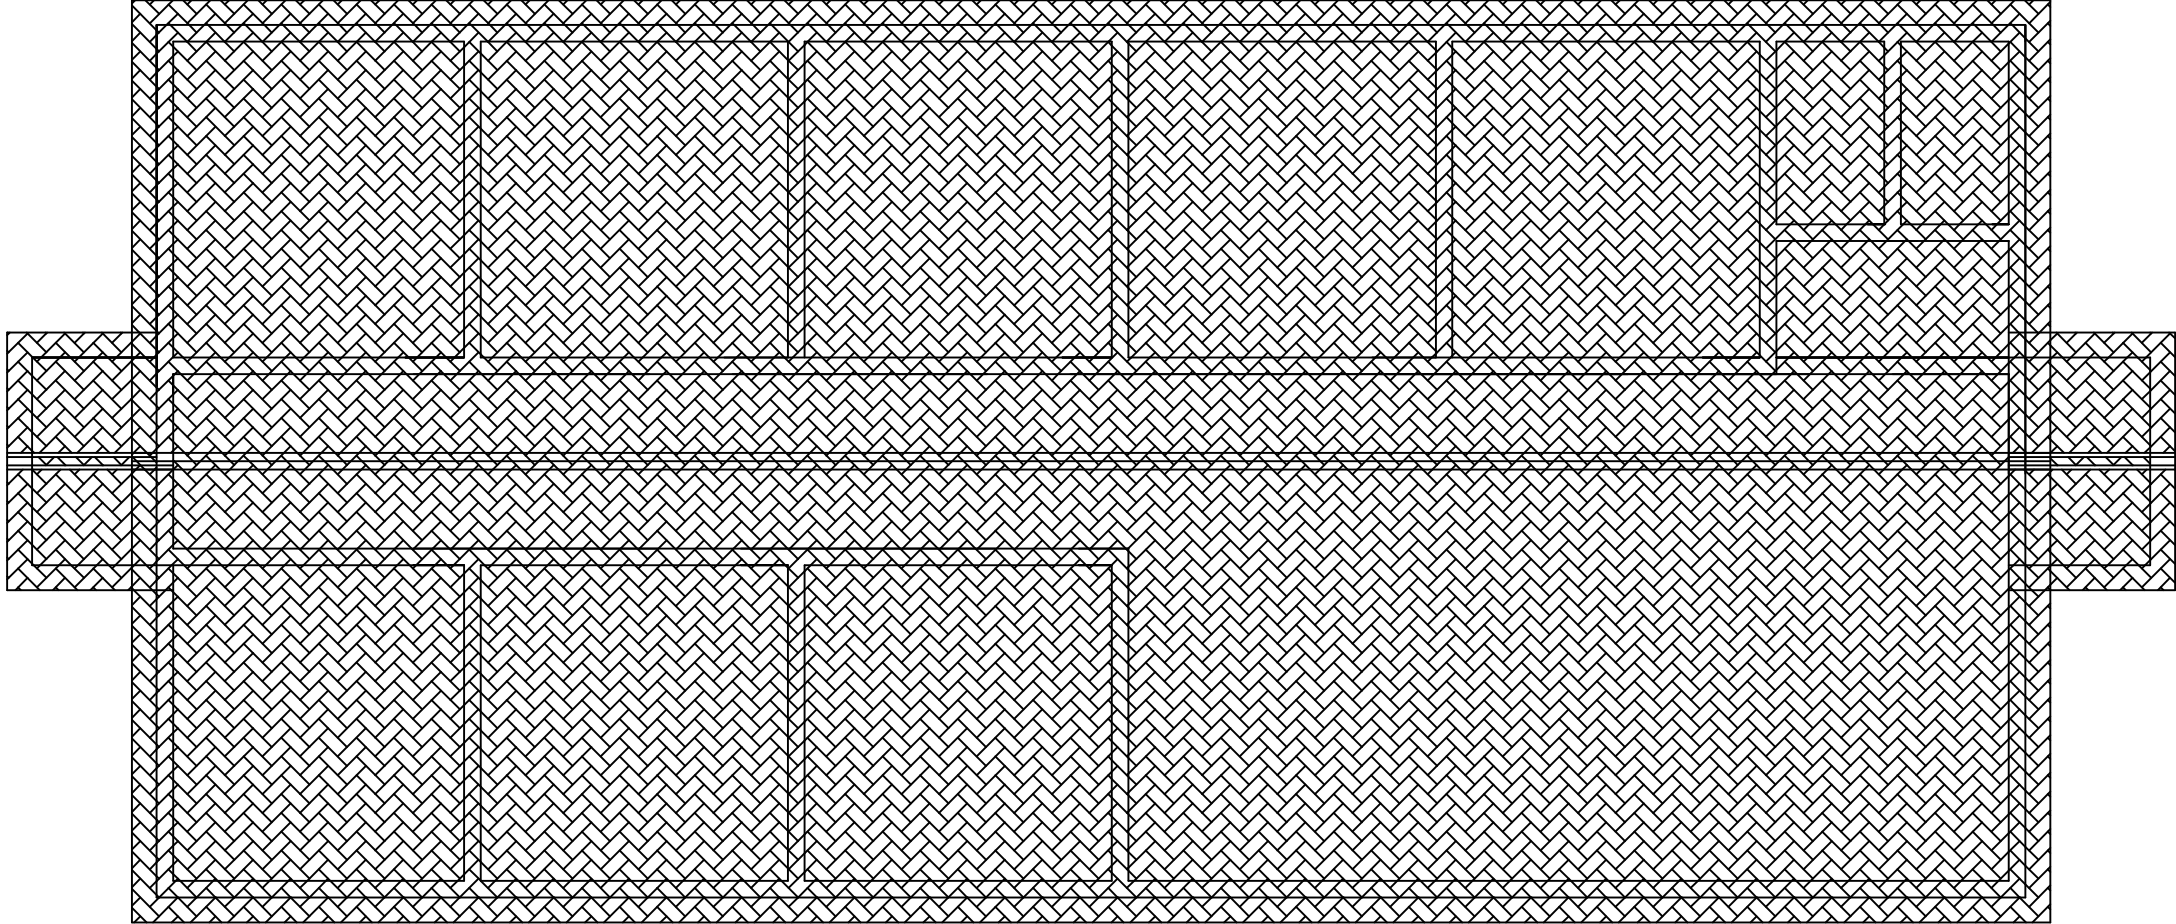

ROOF PLAN LAYOUT
SCALE: 1:100

- Client:**
- 1. All levels and dimensions to be checked on site before any building work commence
 - 2.All works to be strictly in accordance to with standard specification and notes
 - 3. walls below 200mm to be reinforced with hoop iron at every alternate course.
 - 4. This drawing is to be read in conjunction with specifications and all other relevant drawings


Client:	
Nis - Foundation	
project Name:	
Reconstruction of Lasanod hospital	
Drawing title:	
Drawing title:	
prepered by: XXXXXX	checked by: XXXXXX
Scale: 1:100	Date: Feb - 2024
Drawing no: 0001	Revision:

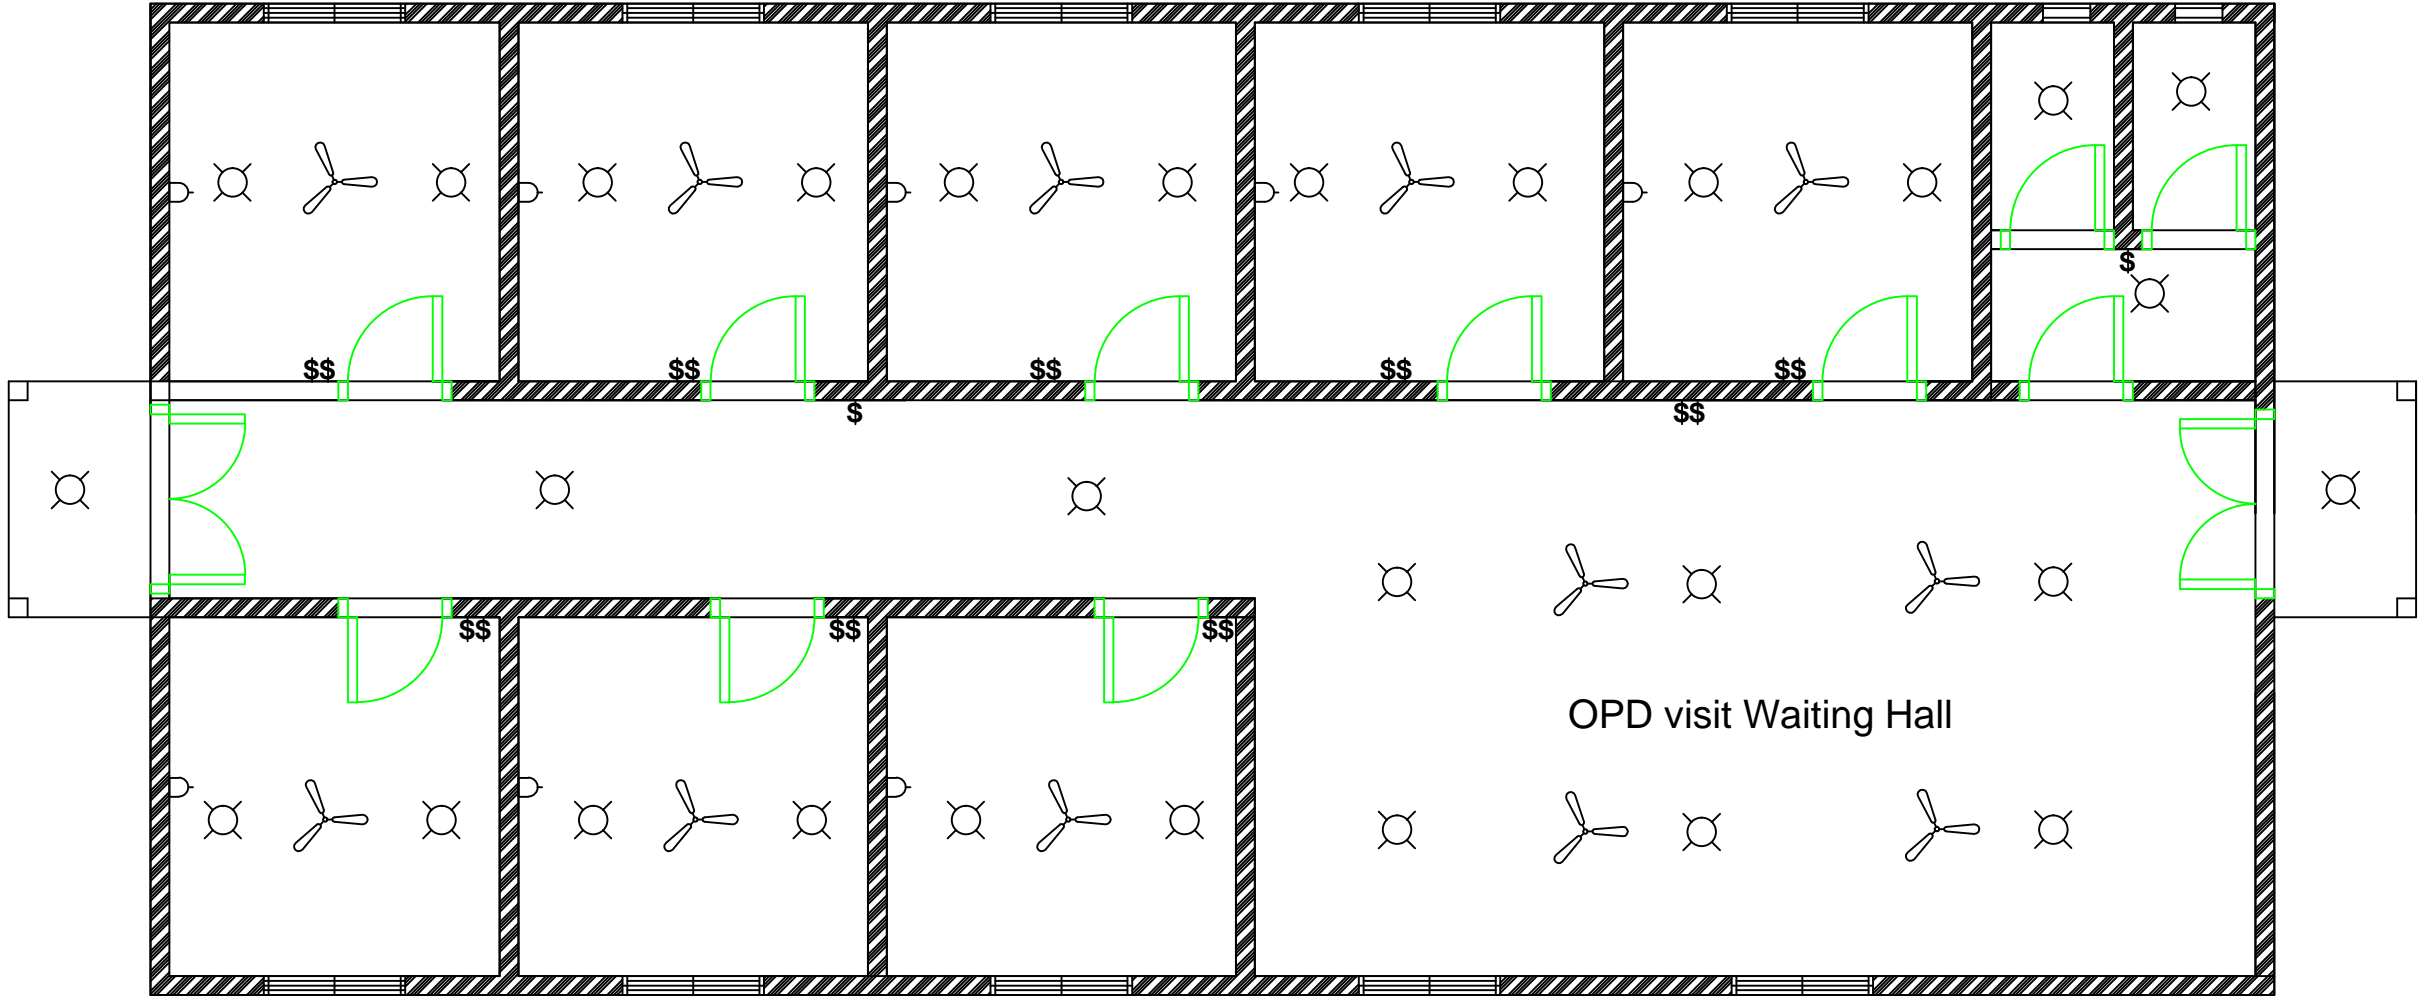


ELECTRIC PLAN LAYOUT
SCALE: 1:100

- Client:
- 1. All levels and dimensions to be checked on site before any building work commence
 - 2.All works to be strictly in accordance to with standard specification and notes
 - 3. walls below 200mm to be reinforced with hoop iron at every alternate course.
 - 4. This drawing is to be read in conjunction with specifications and all other relevant drawings

Client:	
Nis - Foundation	
project Name:	
Reconstruction of Lasanod hospital	
Drawing title:	
Drawing title:	
prepered by:	checked by:
XXXXXX	XXXXXX
Scale:	Date:
1:100	Feb - 2024
Drawing no:	Revision:
0001	

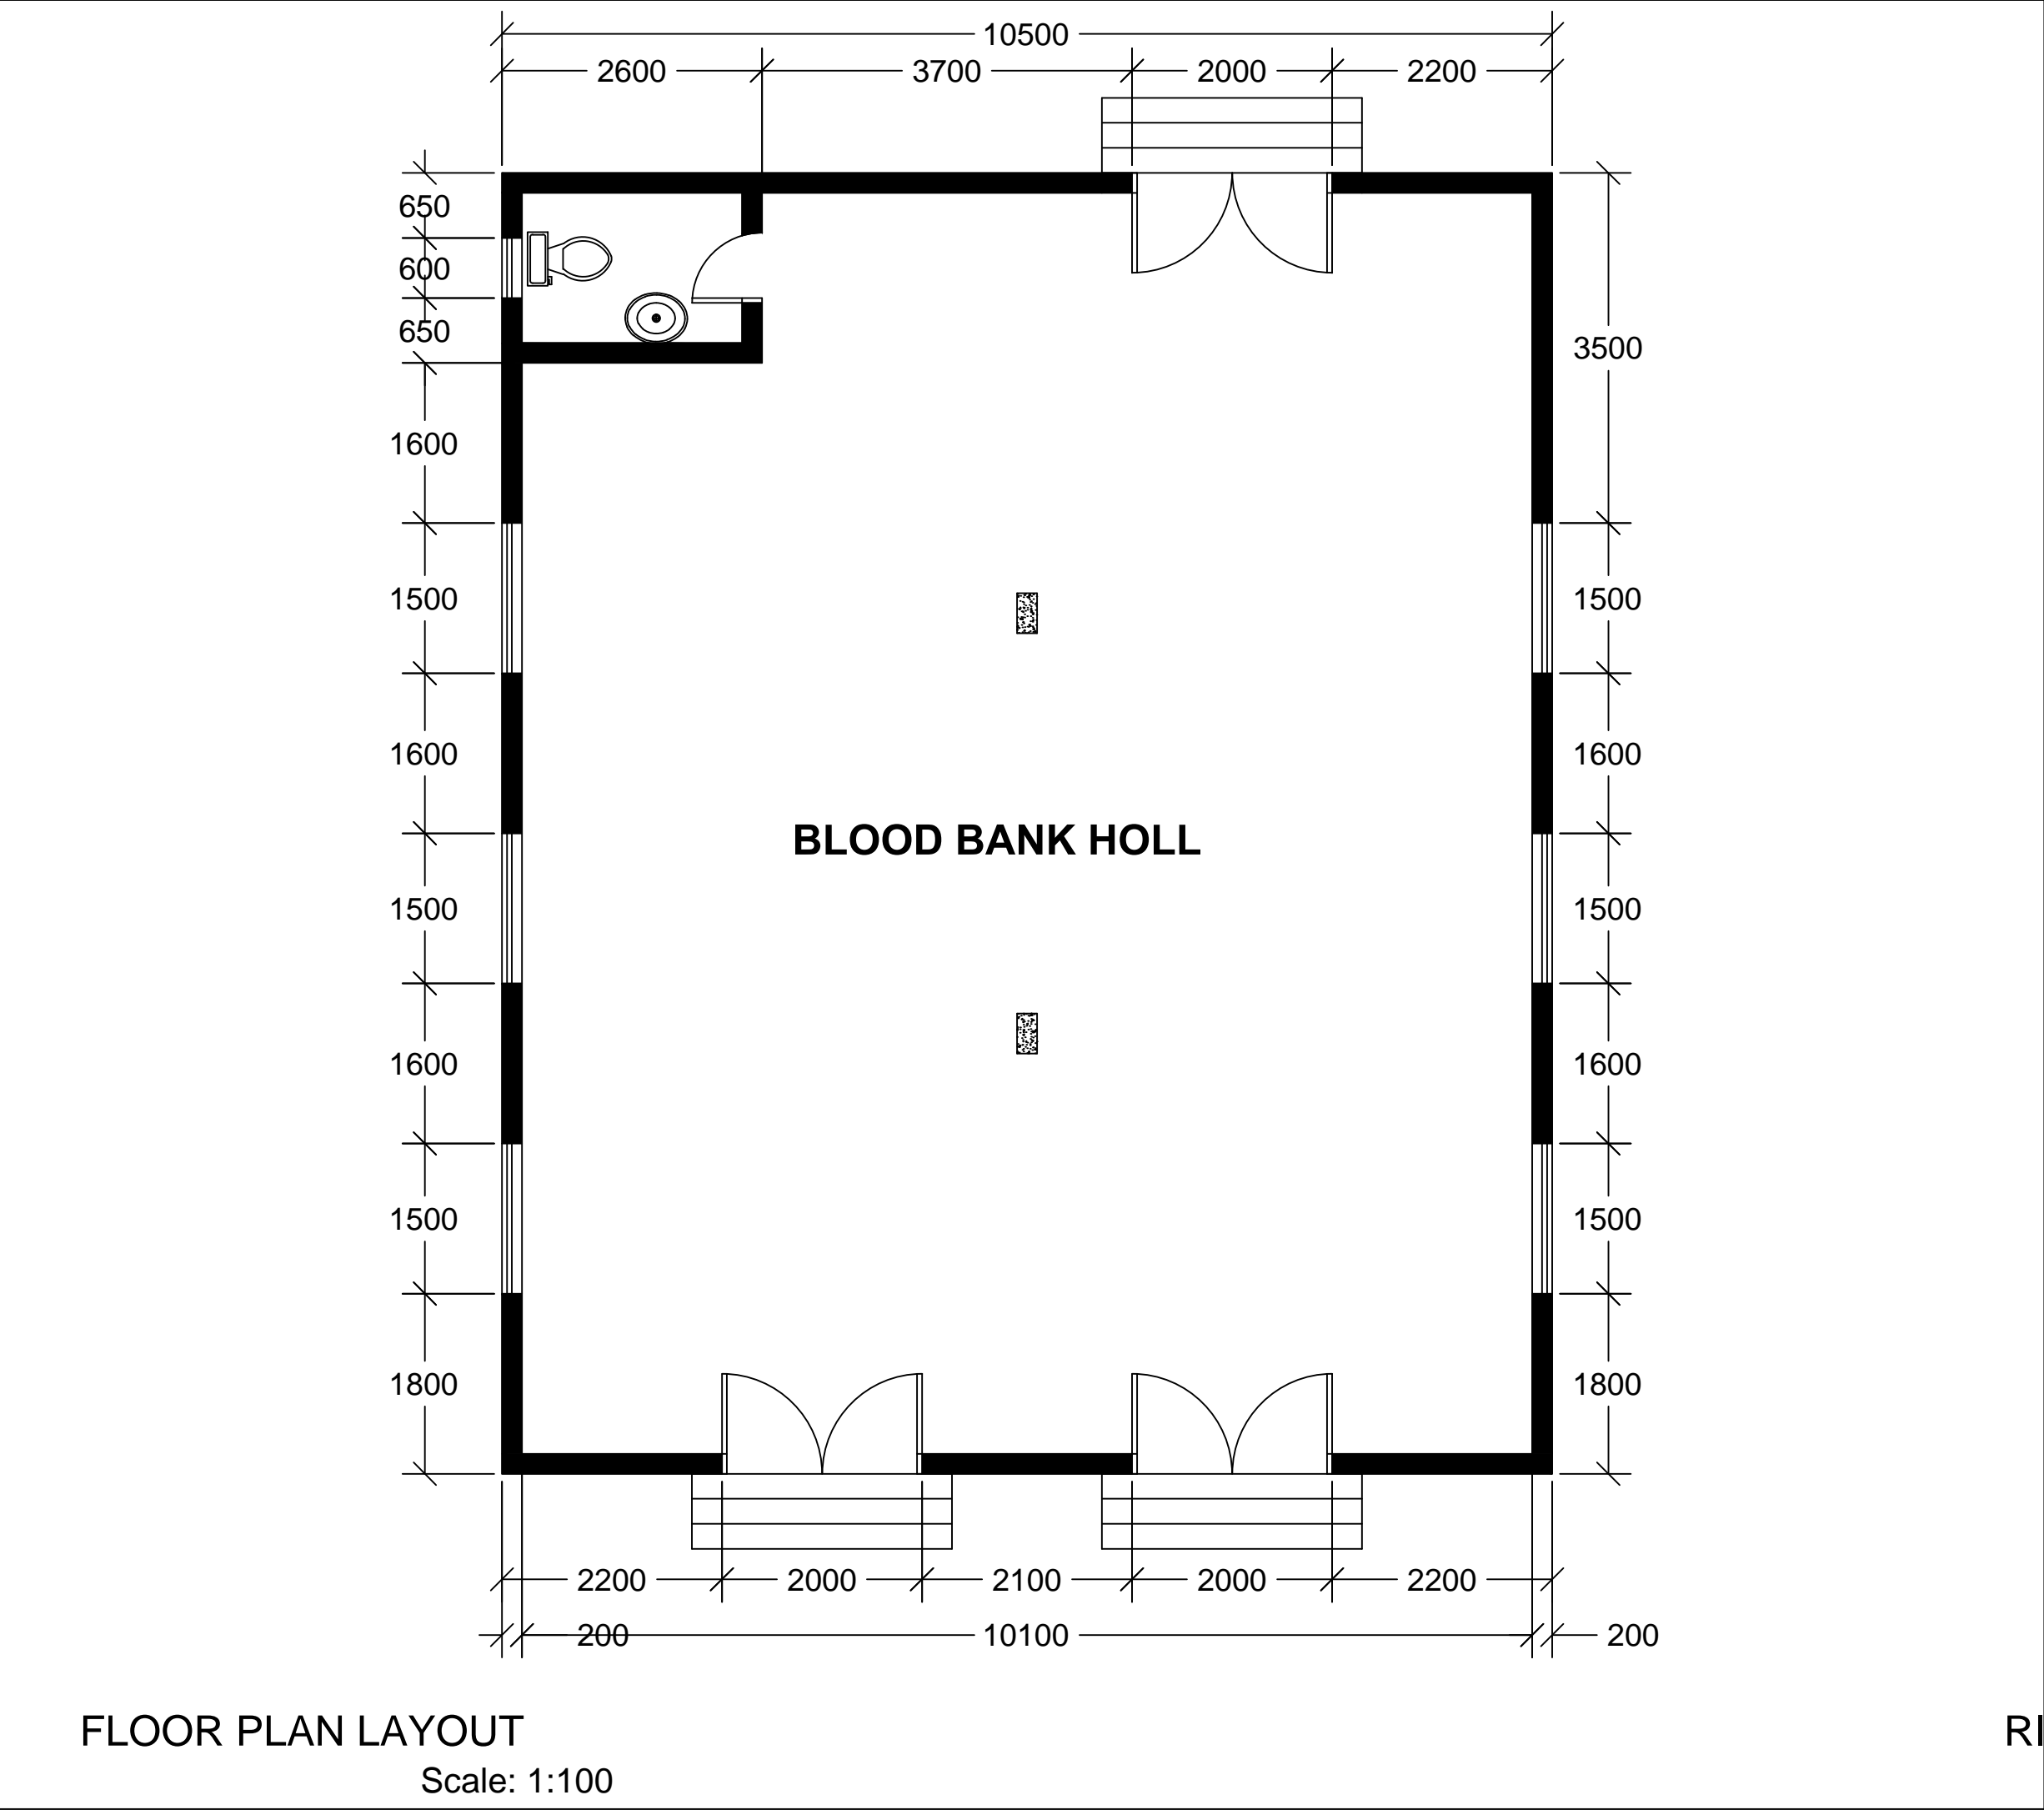

Client: <div>1. All levels and dimensions to be checked on site before any building work commance</div> <div>2.All works to be strictly in accordance to with standard specification and notes</div> <div>3. walls below 200mm to be reinforced with hoop iron at every alternate course.</div> <div>4. This drawing is to be read in conjunction with specifications and all other relevant drawings</div>	
Client: <div>Nis - Foundation</div>	
project Name: <div>Reconstruction of Lasanod hospital</div>	
Drawing title: <div>Drawing title:</div>	
prepered by: <div>XXXXXX</div>	checked by: <div>XXXXXX</div>
Scale: <div>1:100</div>	Date: <div>Feb - 2024</div>
Drawing no: <div>0001</div>	Revision:

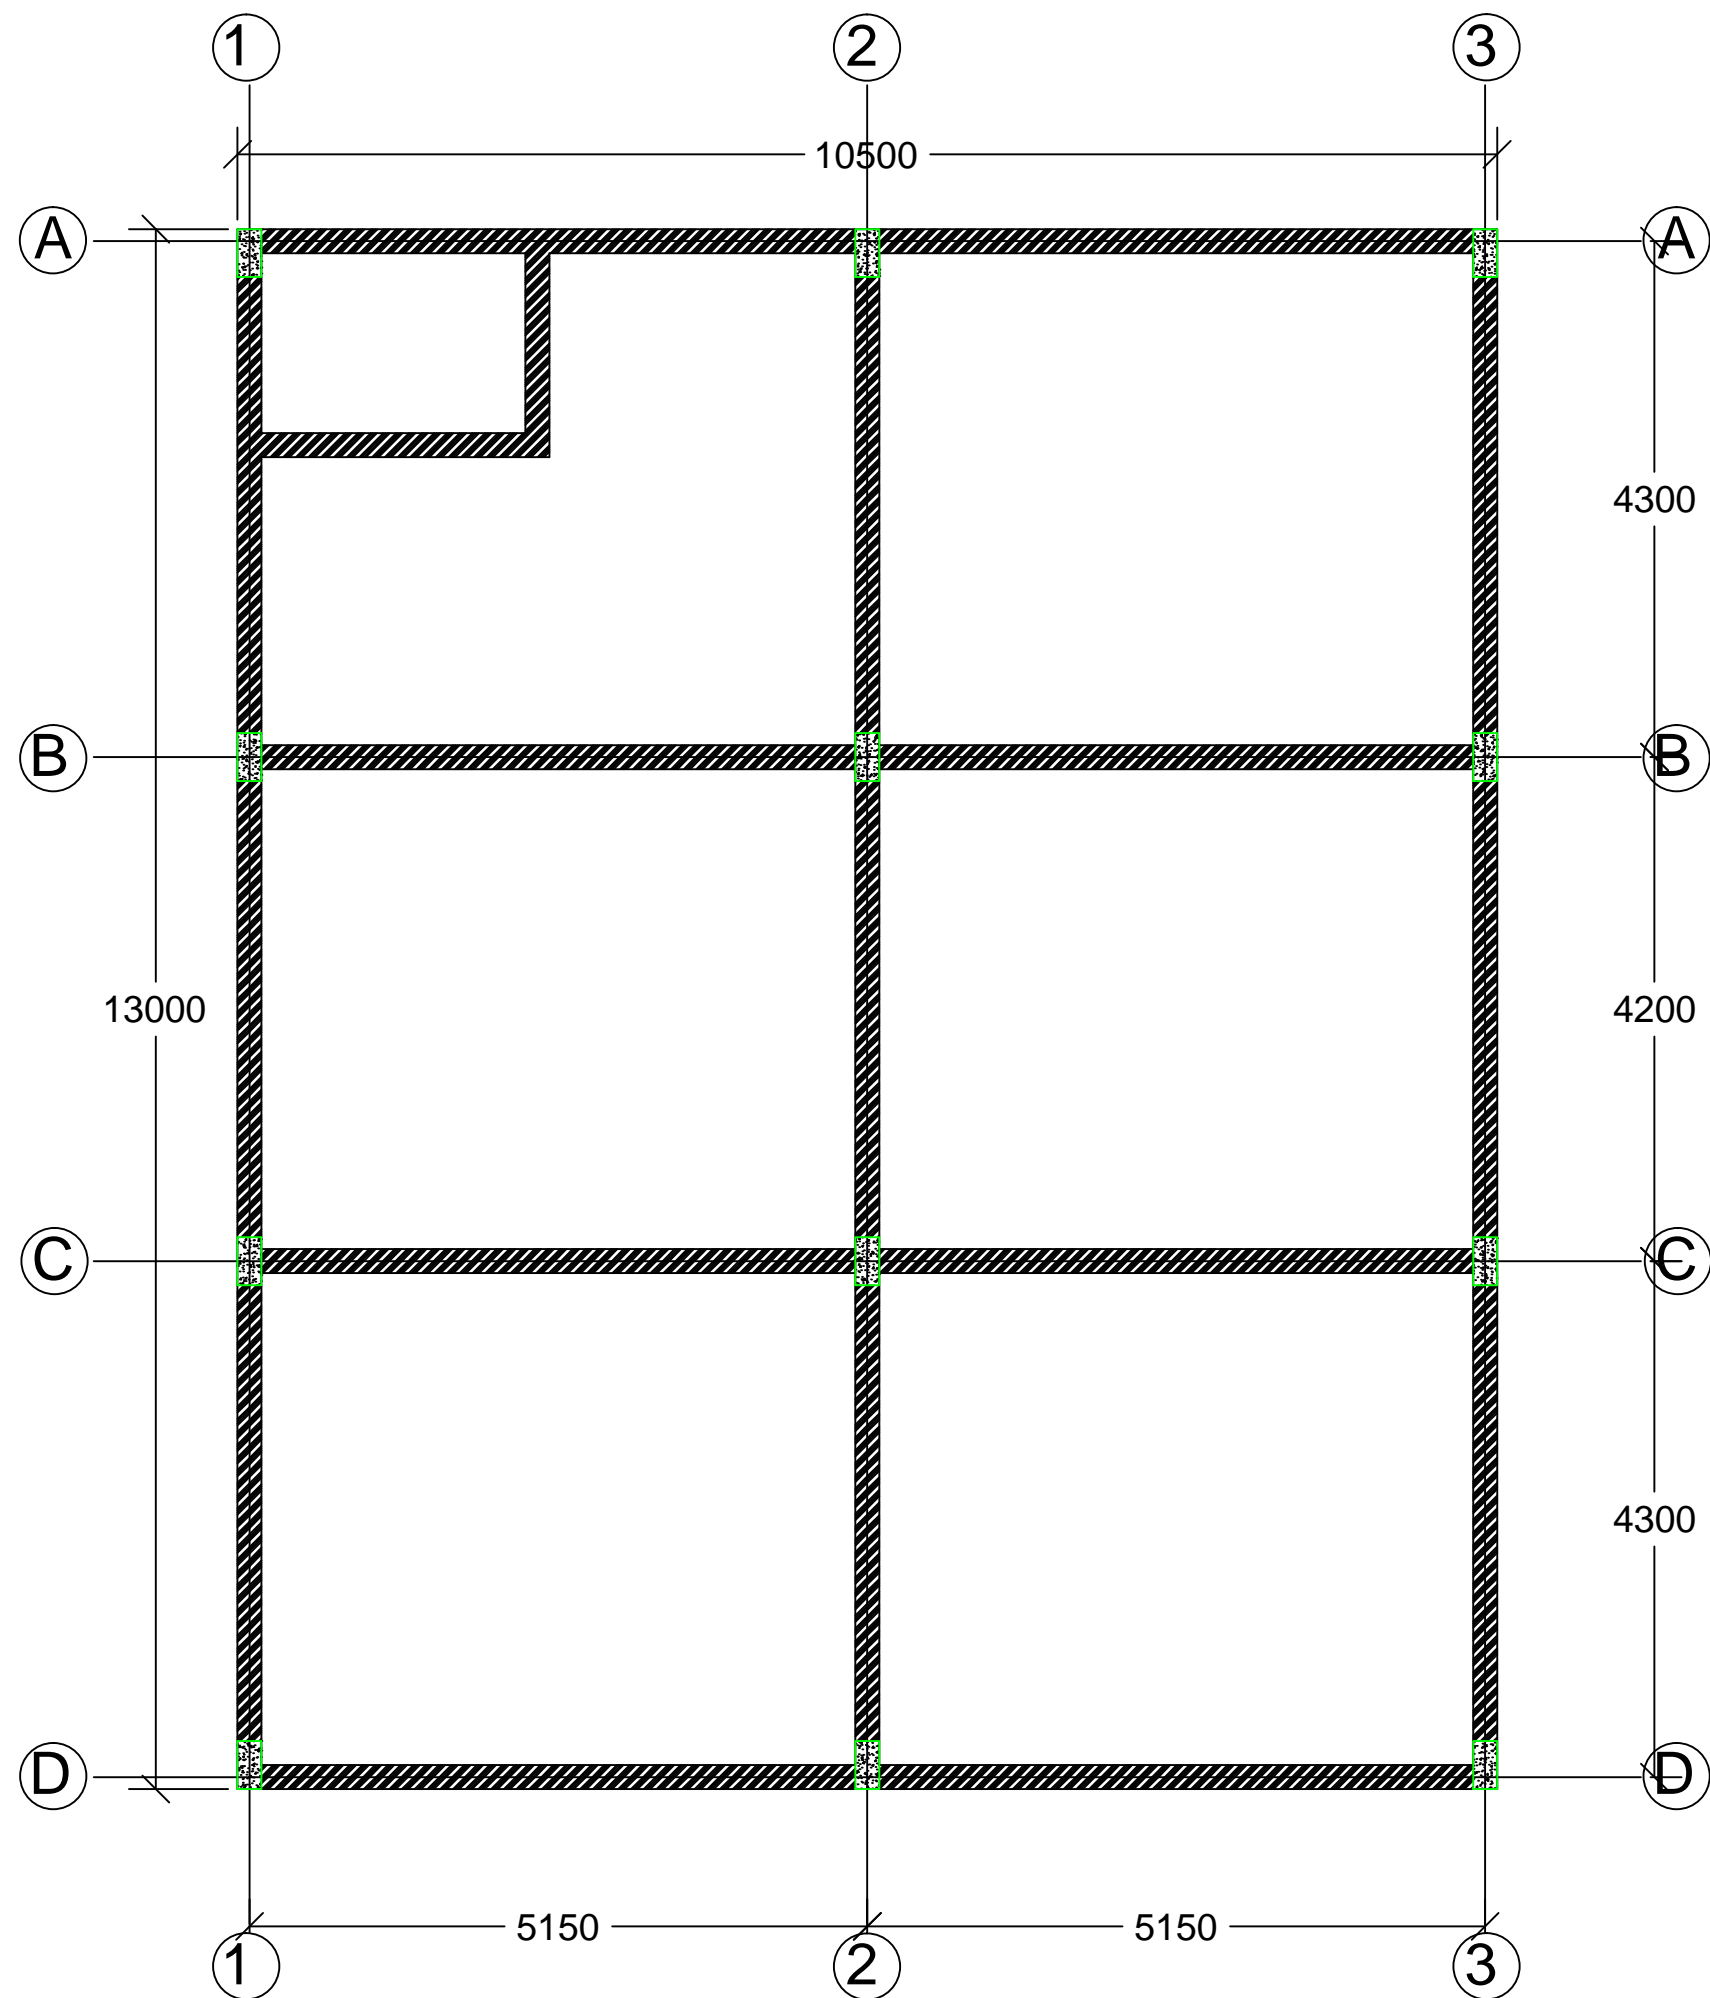

RING BEAM LAYOUT

Scale: 1:100

Client:

1. All levels and dimensions to be checked on site before any building work commence
2. All works to be strictly in accordance to with standard specification and notes
3. walls below 200mm to be reinforced with hoop iron at every alternate course.
4. This drawing is to be read in conjunction with specifications and all other relevant drawings

Client:

Nis - Foundation

project Name:

Reconstruction of Lasanod hospital

Drawing title:

Drawing title:

prepared by:

XXXXXX

checked by:

XXXXXX

Scale:

1:100


Date:

Feb - 2024

Drawing no:

0001

Revision:

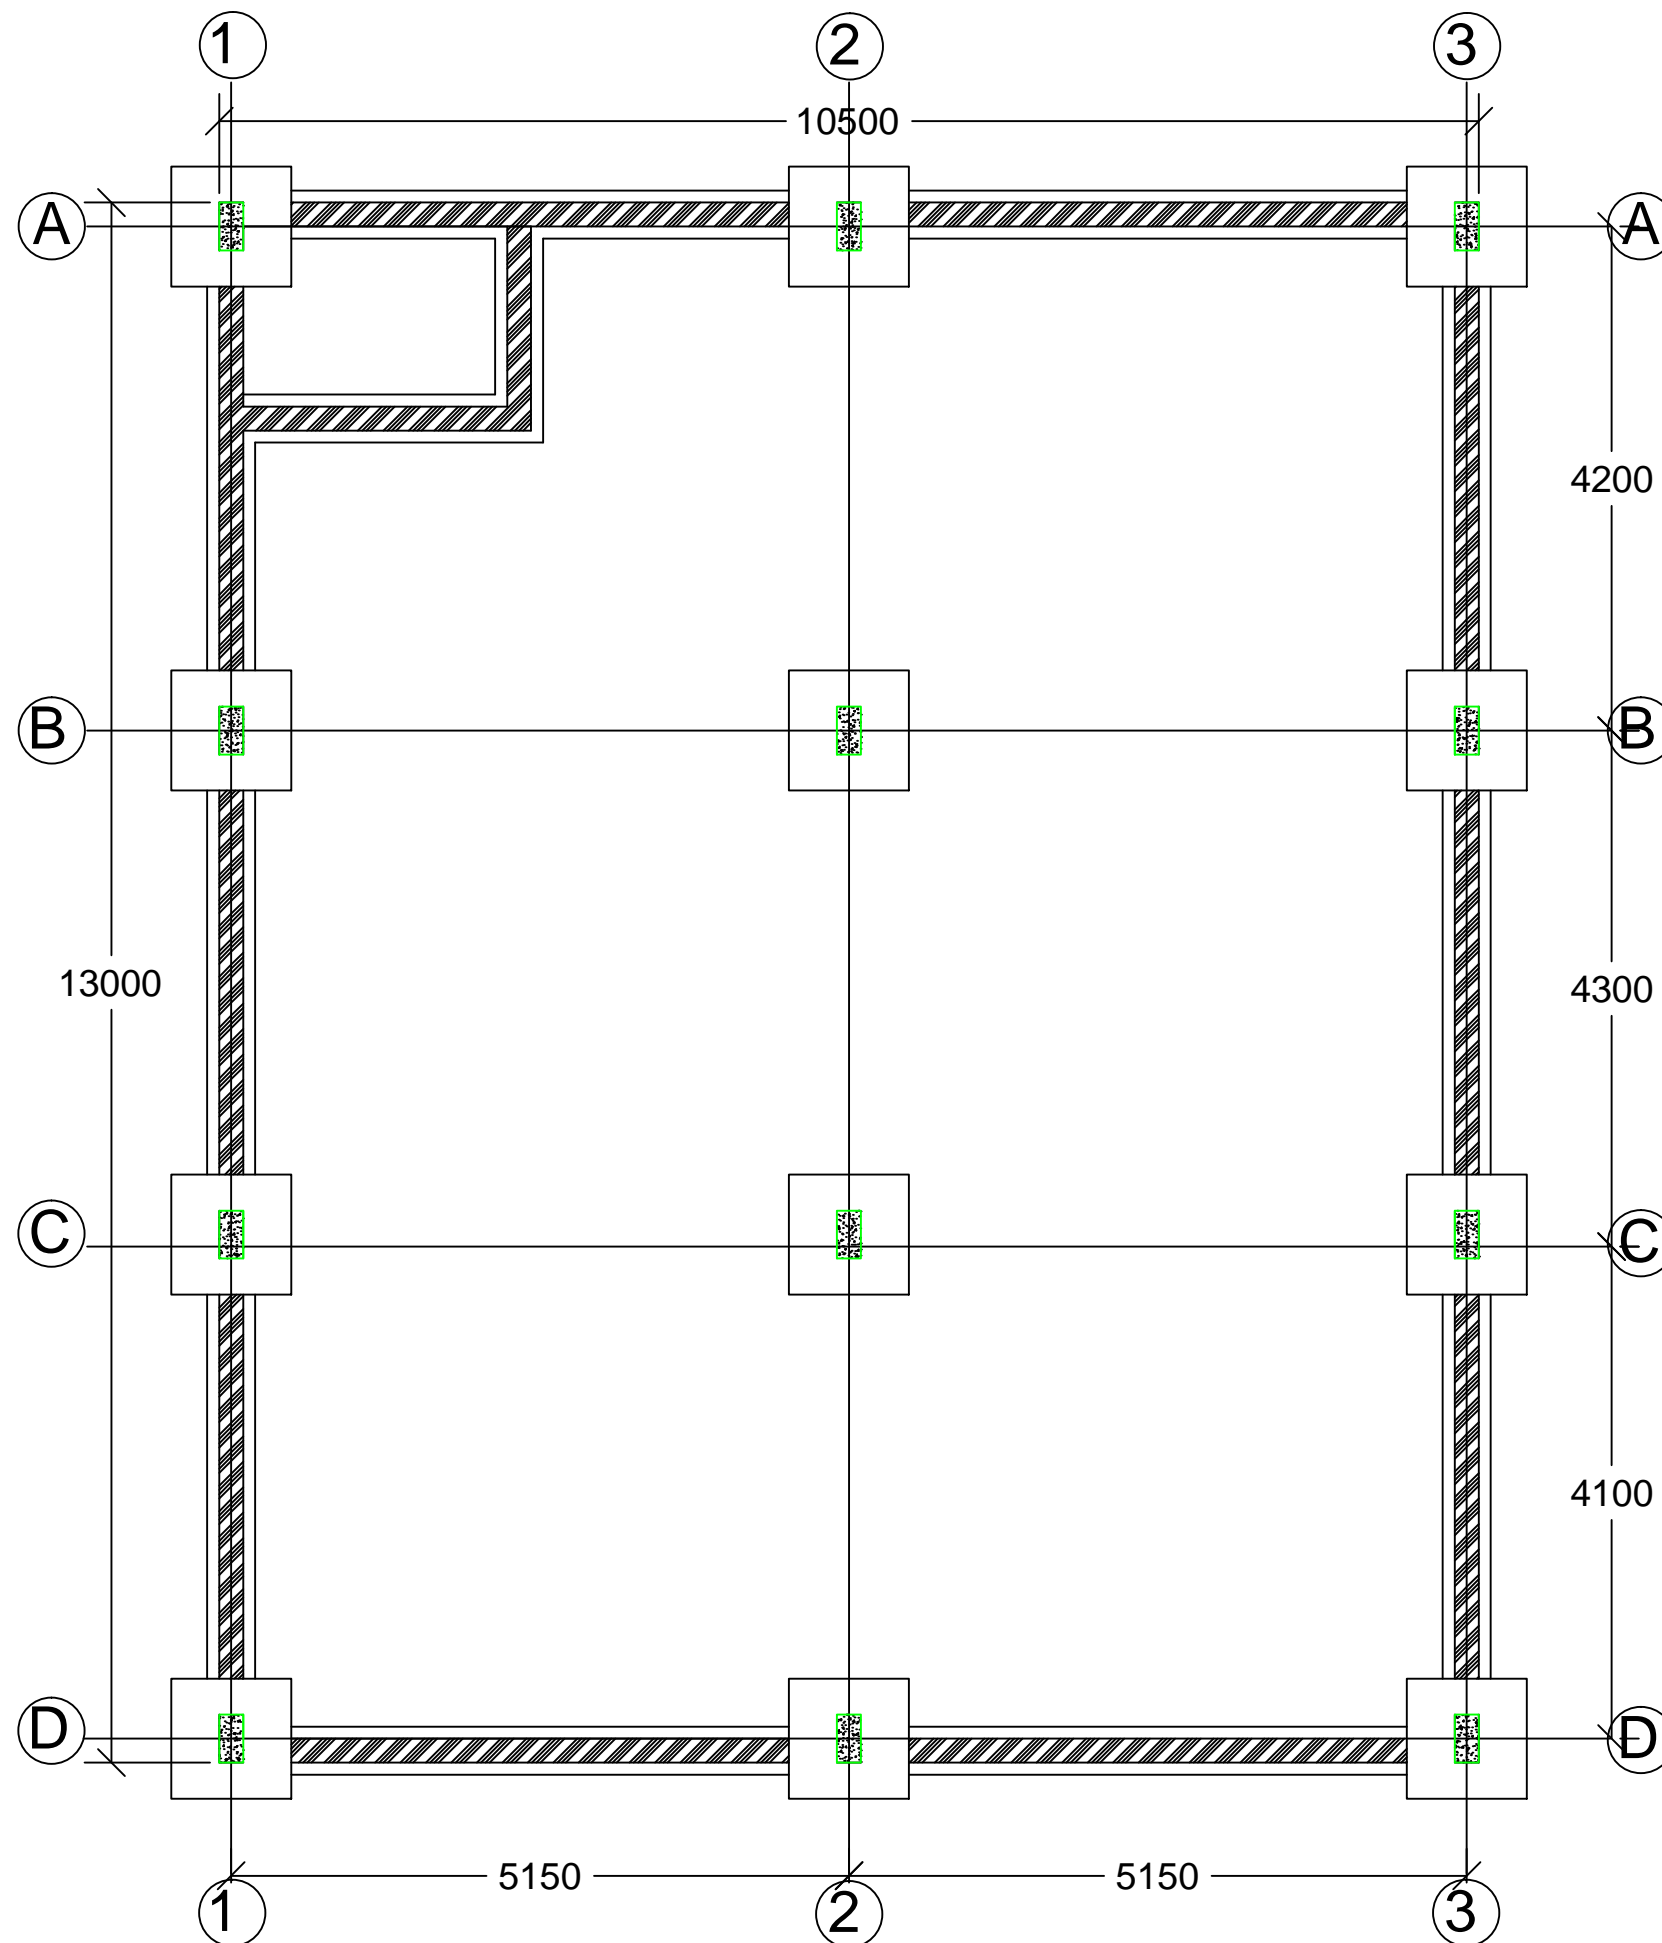

FOUNDATION PLAN LAYOUT
Scale: 1:100

Client:

- 1. All levels and dimensions to be checked on site before any building work commence
- 2.All works to be strictly in accordance to with standard specification and notes
- 3. walls below 200mm to be reinforced with hoop iron at every alternate course.
- 4. This drawing is to be read in conjunction with specifications and all other relevant drawings

Client:

Nis - Foundation

project Name:

Reconstruction of Lasanod hospital

Drawing title:

Drawing title:

prepered by:
XXXXXX



checked by:
XXXXXX

Scale:
1:100

Date:
Feb - 2024

Drawing no:
0001

Revision:

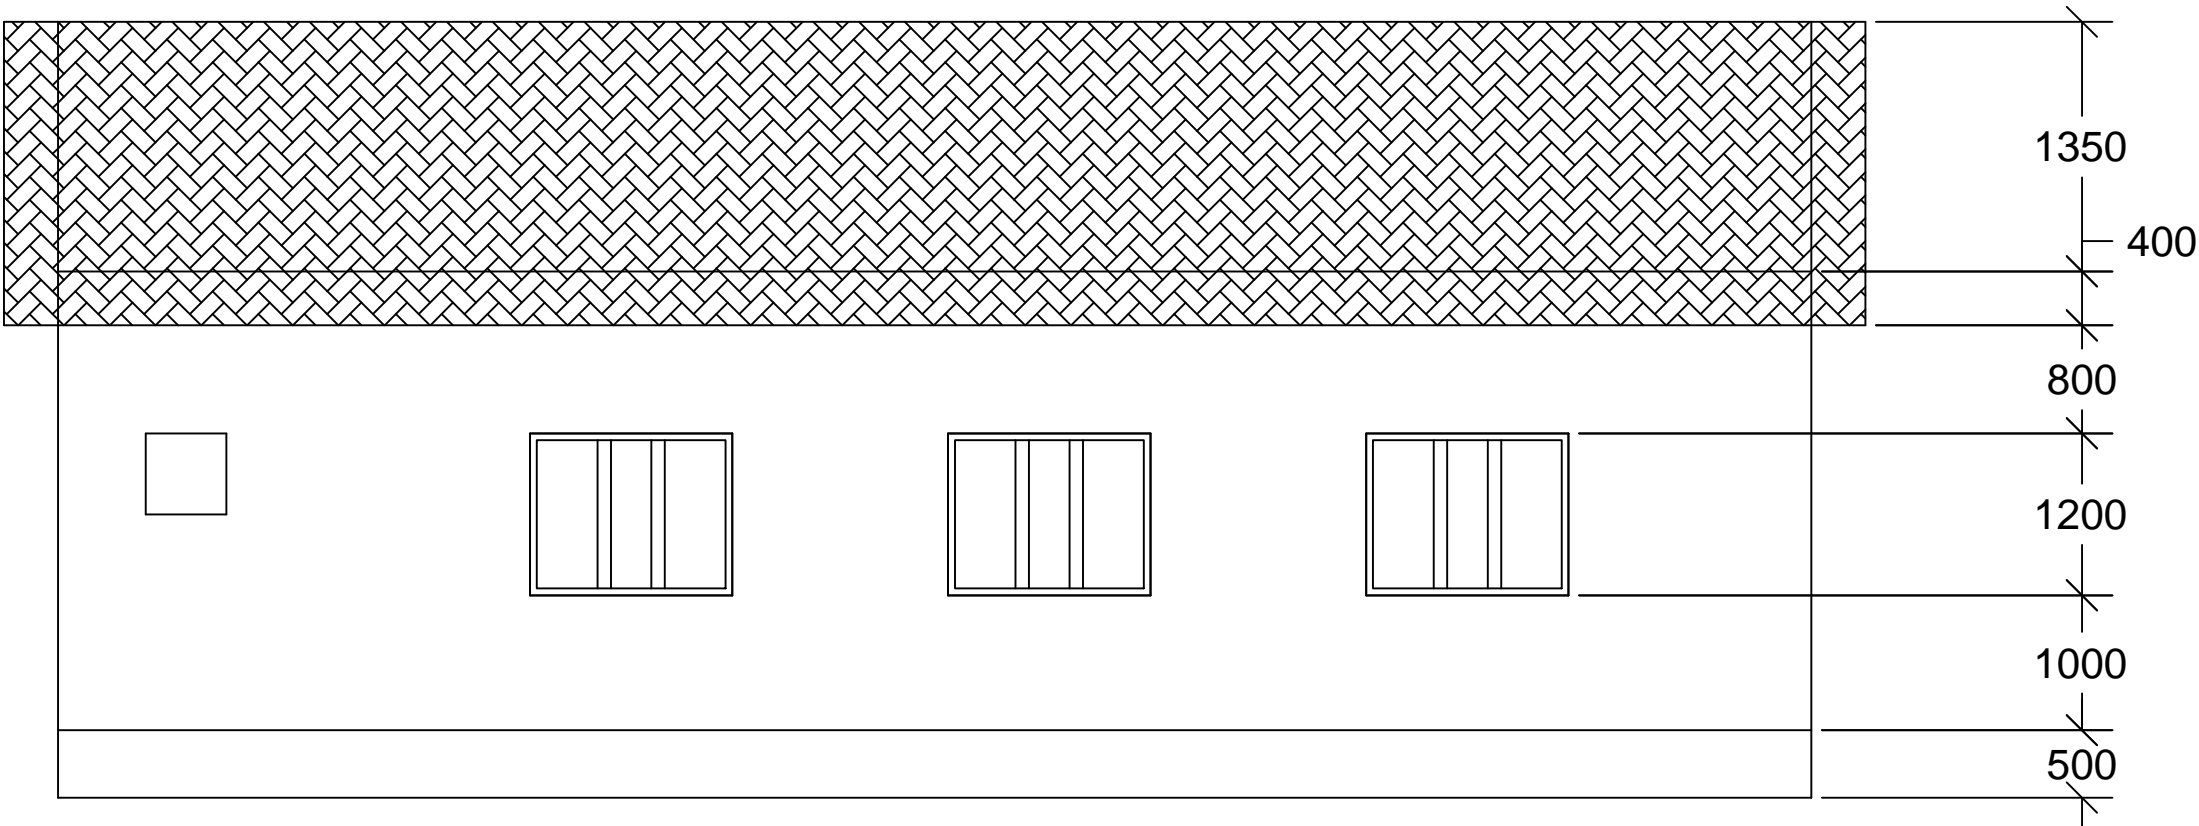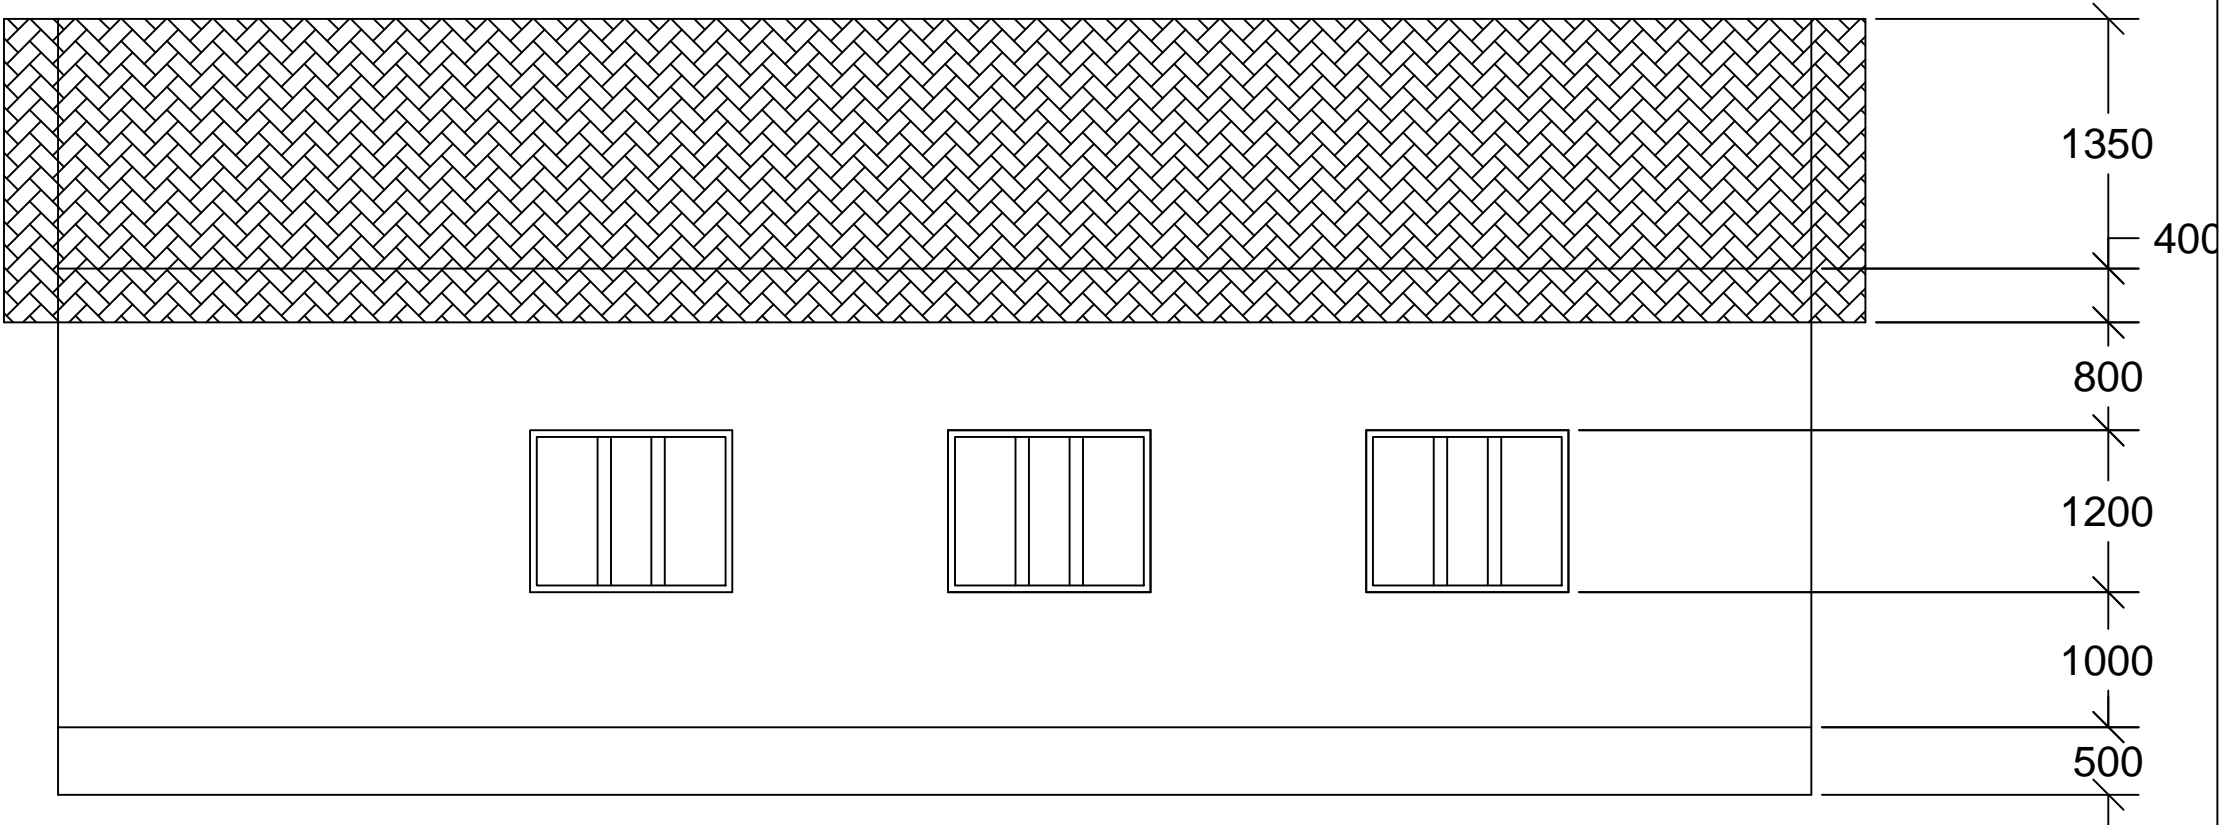

ELEVATION VIEW 01

Scale: 1:100


- Client:
1. All levels and dimensions to be checked on site before any building work commence
 - 2.All works to be strictly in accordance to with standard specification and notes
 3. walls below 200mm to be reinforced with hoop iron at every alternate course.
 4. This drawing is to be read in conjunction with specifications and all other relevant drawings

Client:	
Nis - Foundation	
project Name:	
Reconstruction of Lasanod hospital	
Drawing title:	
Drawing title:	
prepered by:	checked by:
XXXXXX	XXXXXX
Scale:	Date:
1:100	Feb - 2024
Drawing no:	Revision:
0001	



ELEVATION VIEW 02
Scale: 1:100

<div>Client:</div> <div><div>1. All levels and dimensions to be checked on site before any building work commance</div><div>2.All works to be strictly in accordance to with standard specification and notes</div><div>3. walls below 200mm to be reinforced with hoop iron at every alternate course.</div><div>4. This drawing is to be read in conjunction with specifications and all other relevant drawings</div></div>	
<div>Client:</div> <div>Nis - Foundation</div>	
<div>project Name:</div> <div>Reconstruction of Lasanod hospital</div>	
<div>Drawing title:</div> <div>Drawing title:</div>	
<div>prepered by:</div> <div>XXXXXX</div>	<div>checked by:</div> <div>XXXXXX</div>
<div>Scale:</div> <div>1:100</div>	<div>Date:</div> <div>Feb - 2024</div>
<div>Drawing no:</div> <div>0001</div>	<div>Revision:</div> <div></div>

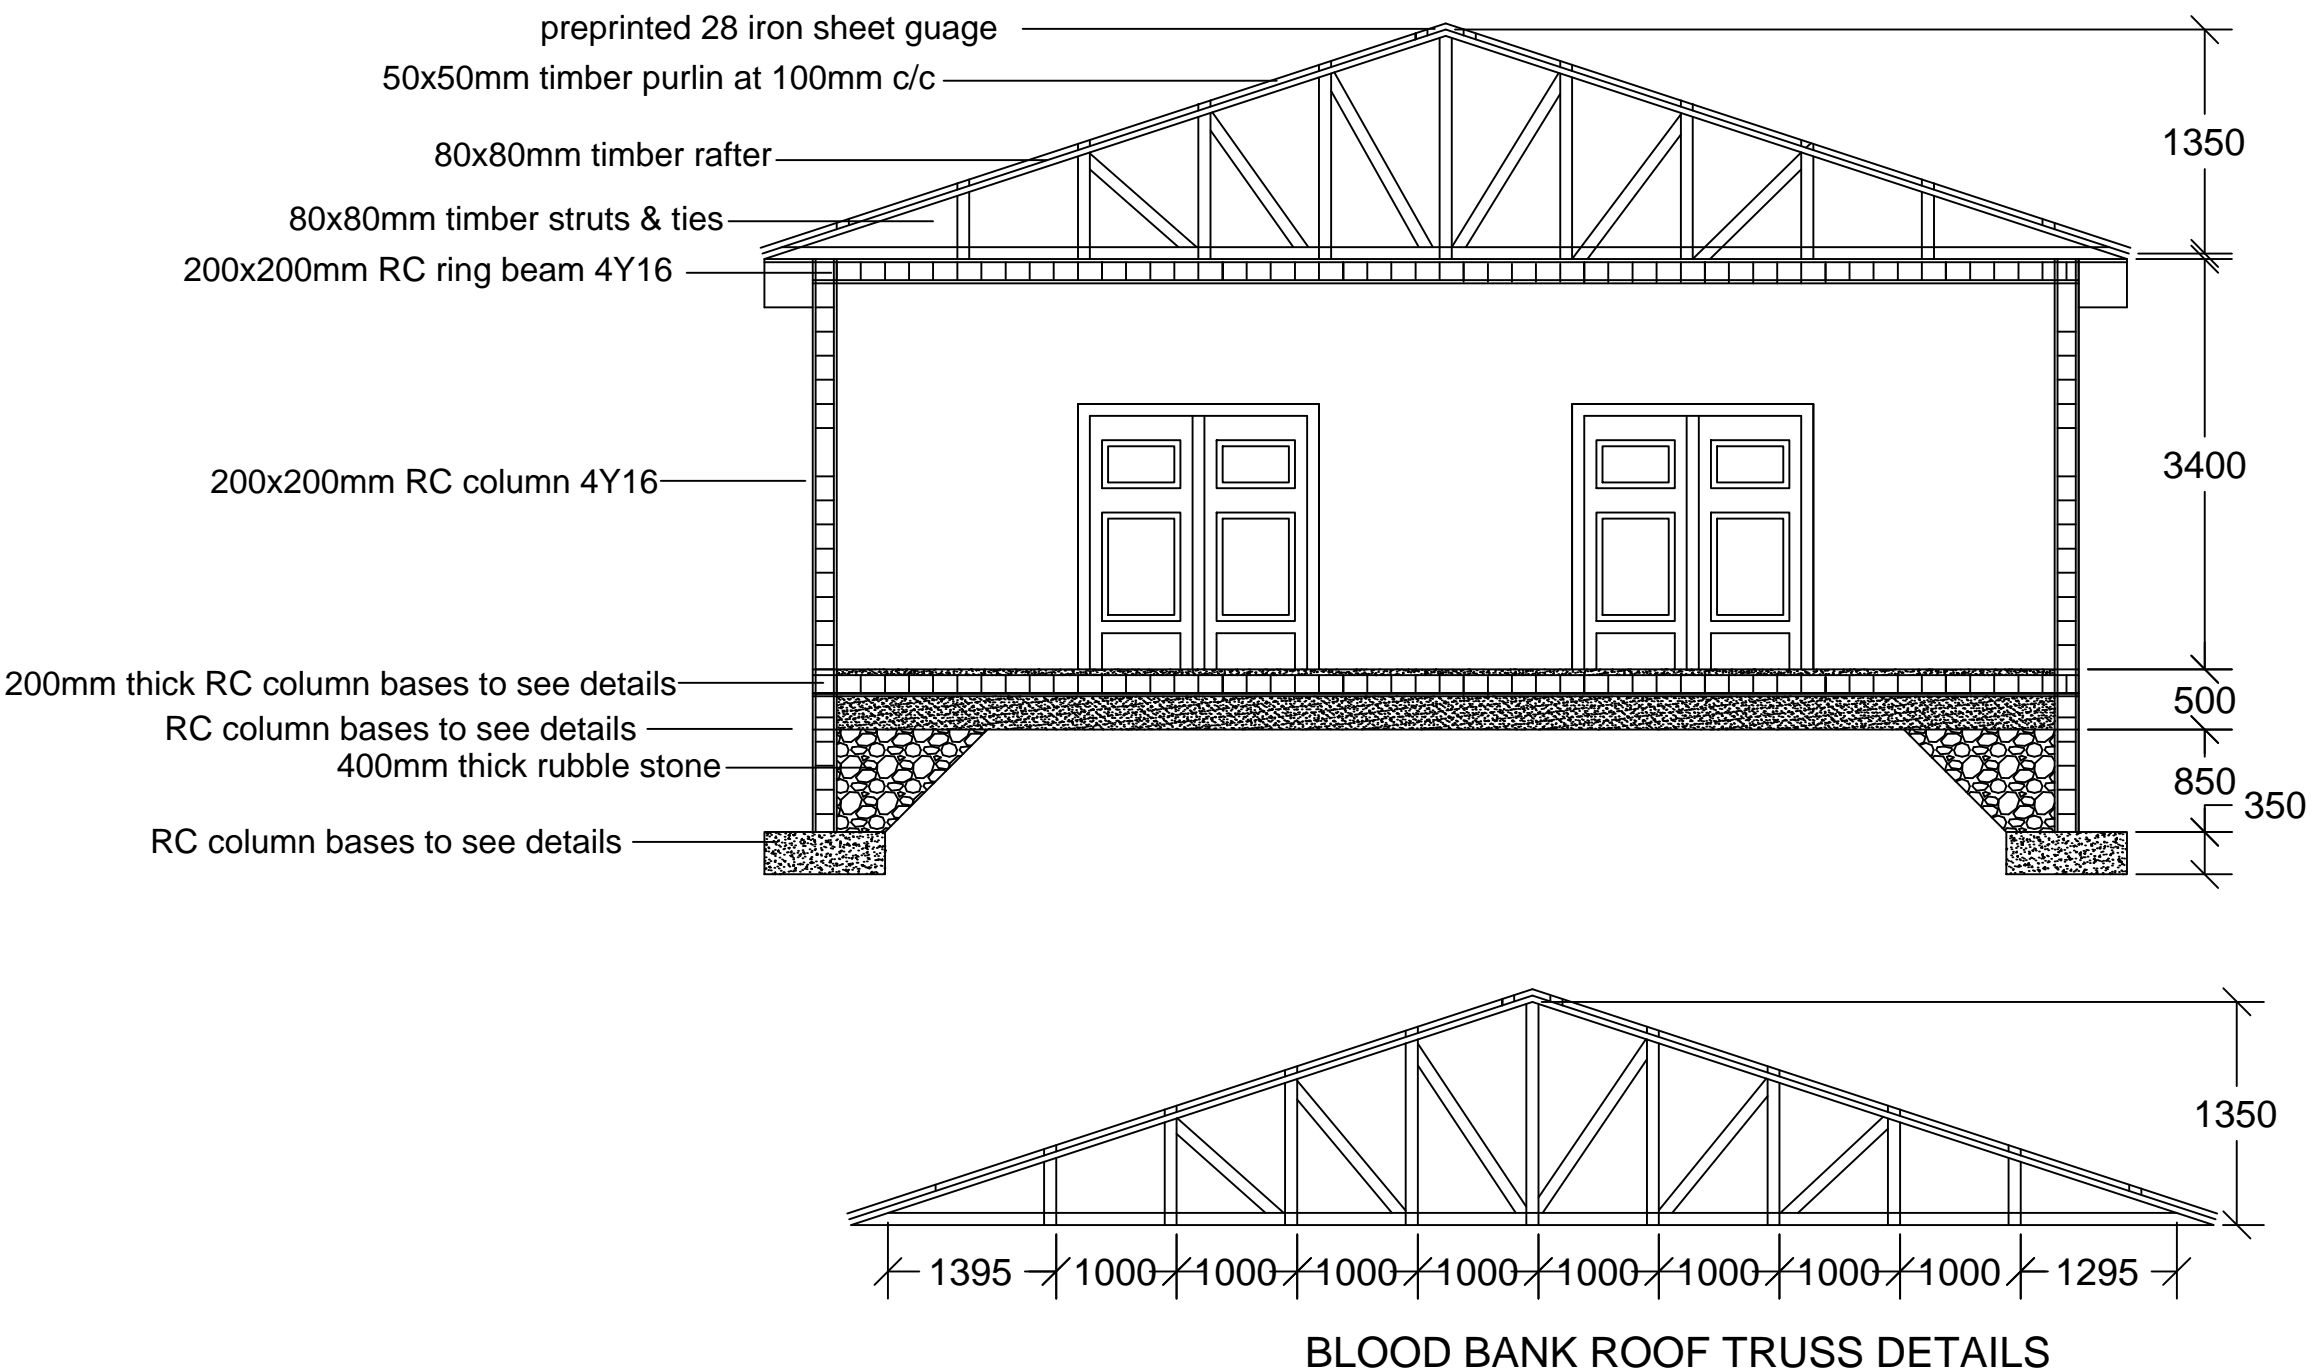


SECTION DETAILS

Scale: 1:100

- Client:
- 1. All levels and dimensions to be checked on site before any building work commence
 - 2.All works to be strictly in accordance to with standard specification and notes
 - 3. walls below 200mm to be reinforced with hoop iron at every alternate course.
 - 4. This drawing is to be read in conjunction with specifications and all other relevant drawings


Client:	
Nis - Foundation	
project Name:	
Reconstruction of Lasanod hospital	
Drawing title:	
Drawing title:	
prepered by:	checked by:
XXXXXX	XXXXXX
Scale:	Date:
1:100	Feb - 2024
Drawing no:	Revision:
0001	

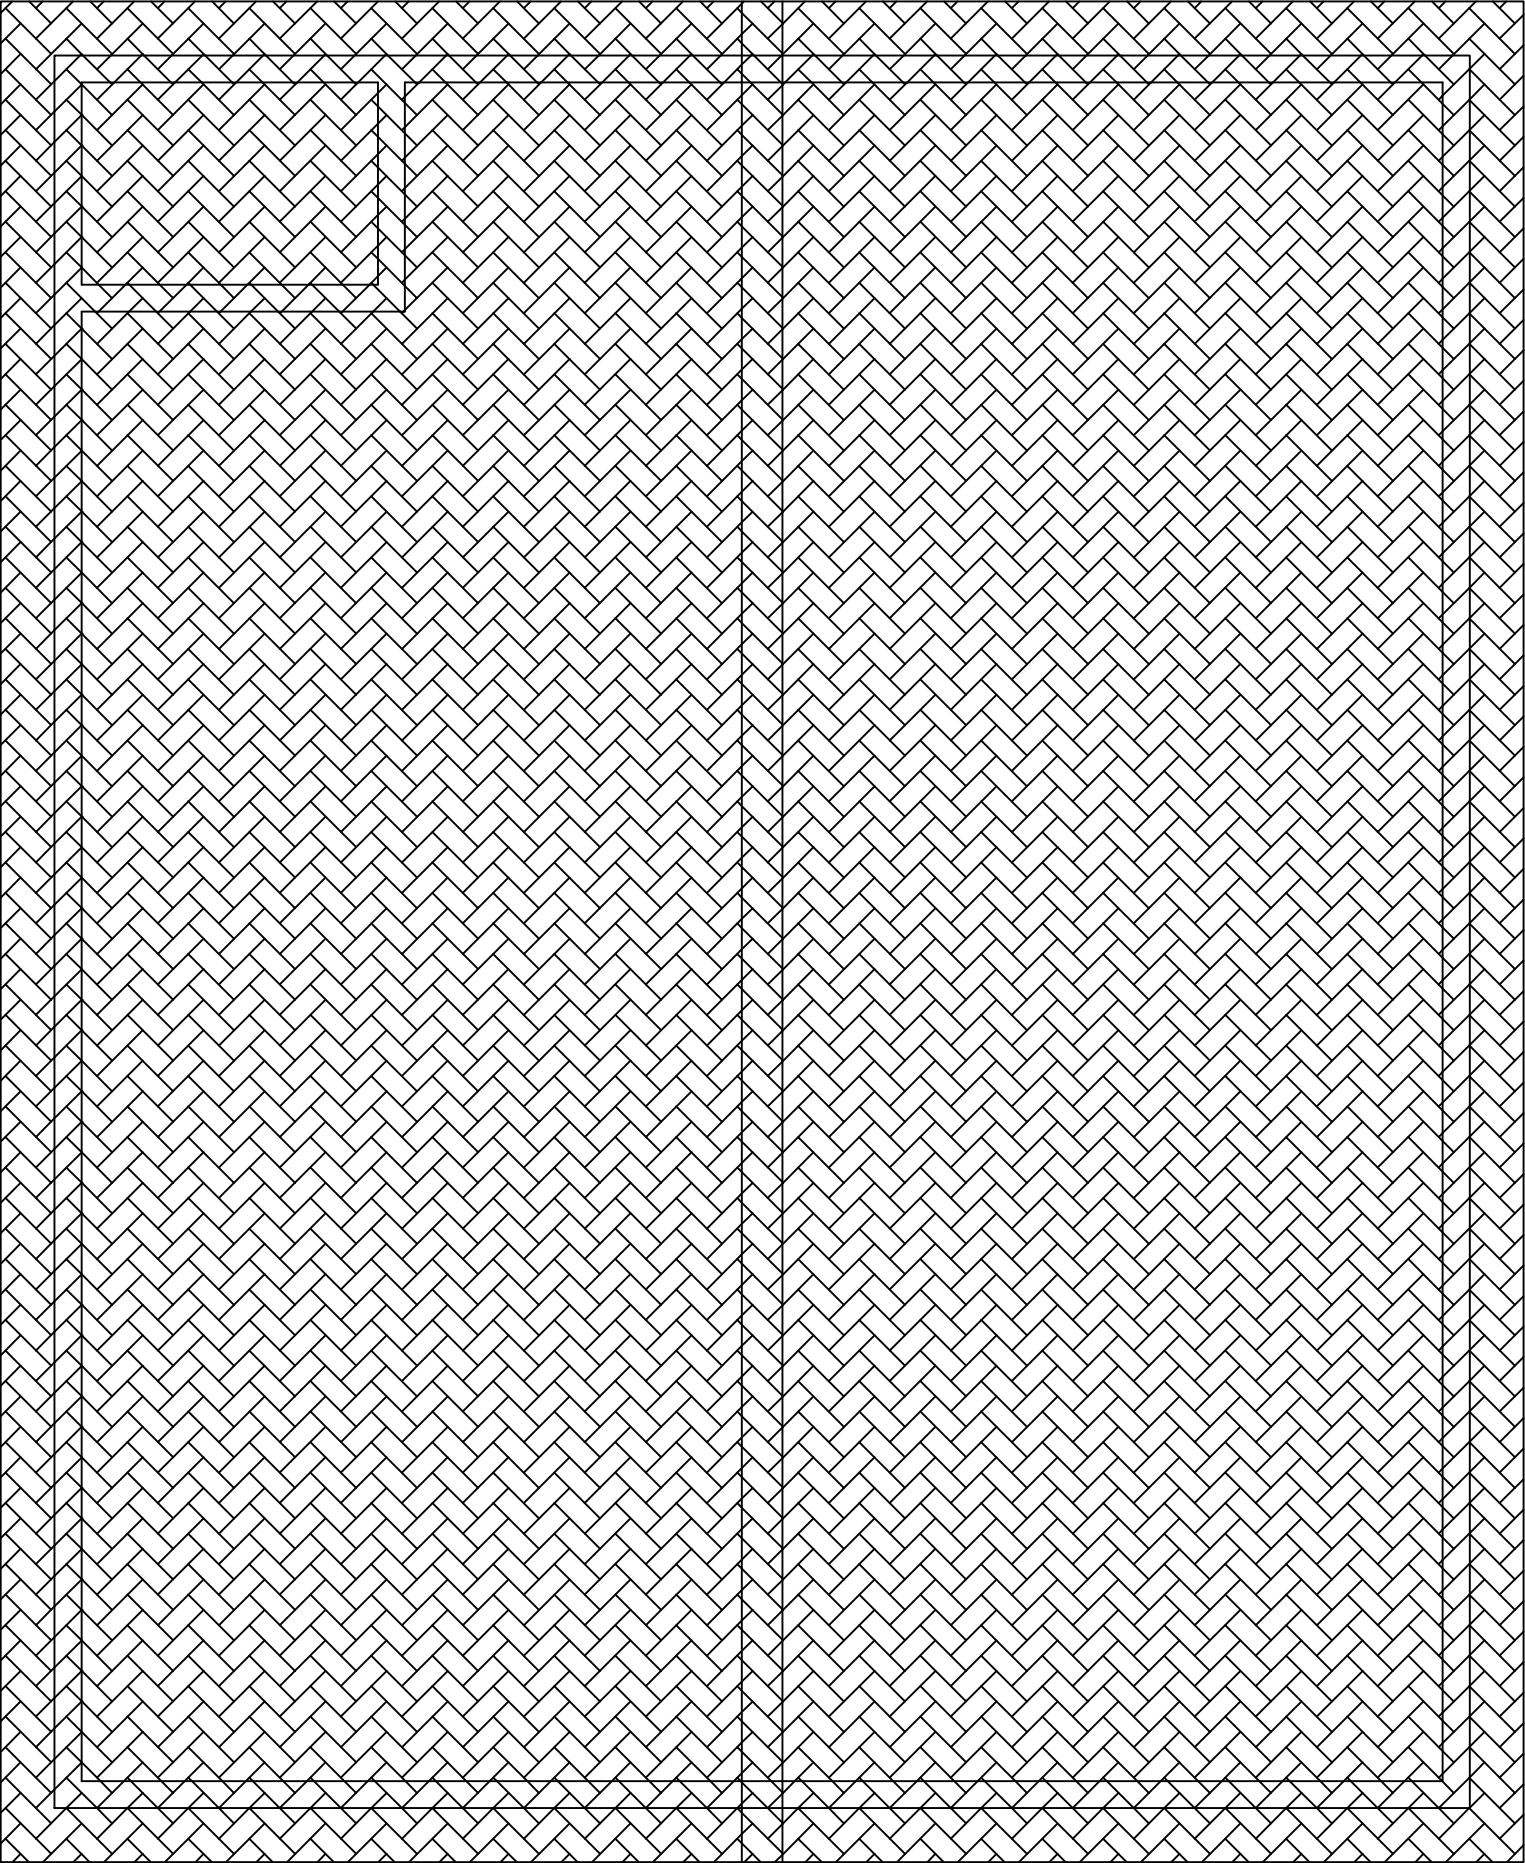

ROOF PLAN LAYOUT
Scale: 1:100

- Client:
- 1. All levels and dimensions to be checked on site before any building work commence
 - 2.All works to be strictly in accordance to with standard specification and notes
 - 3. walls below 200mm to be reinforced with hoop iron at every alternate course.
 - 4. This drawing is to be read in conjunction with specifications and all other relevant drawings

Client:	
Nis - Foundation	
project Name:	
Reconstruction of Lasanod hospital	
Drawing title:	
Drawing title:	
prepered by:	checked by:
XXXXXX	XXXXXX
Scale:	Date:
1:100	Feb - 2024
Drawing no:	Revision:
0001	

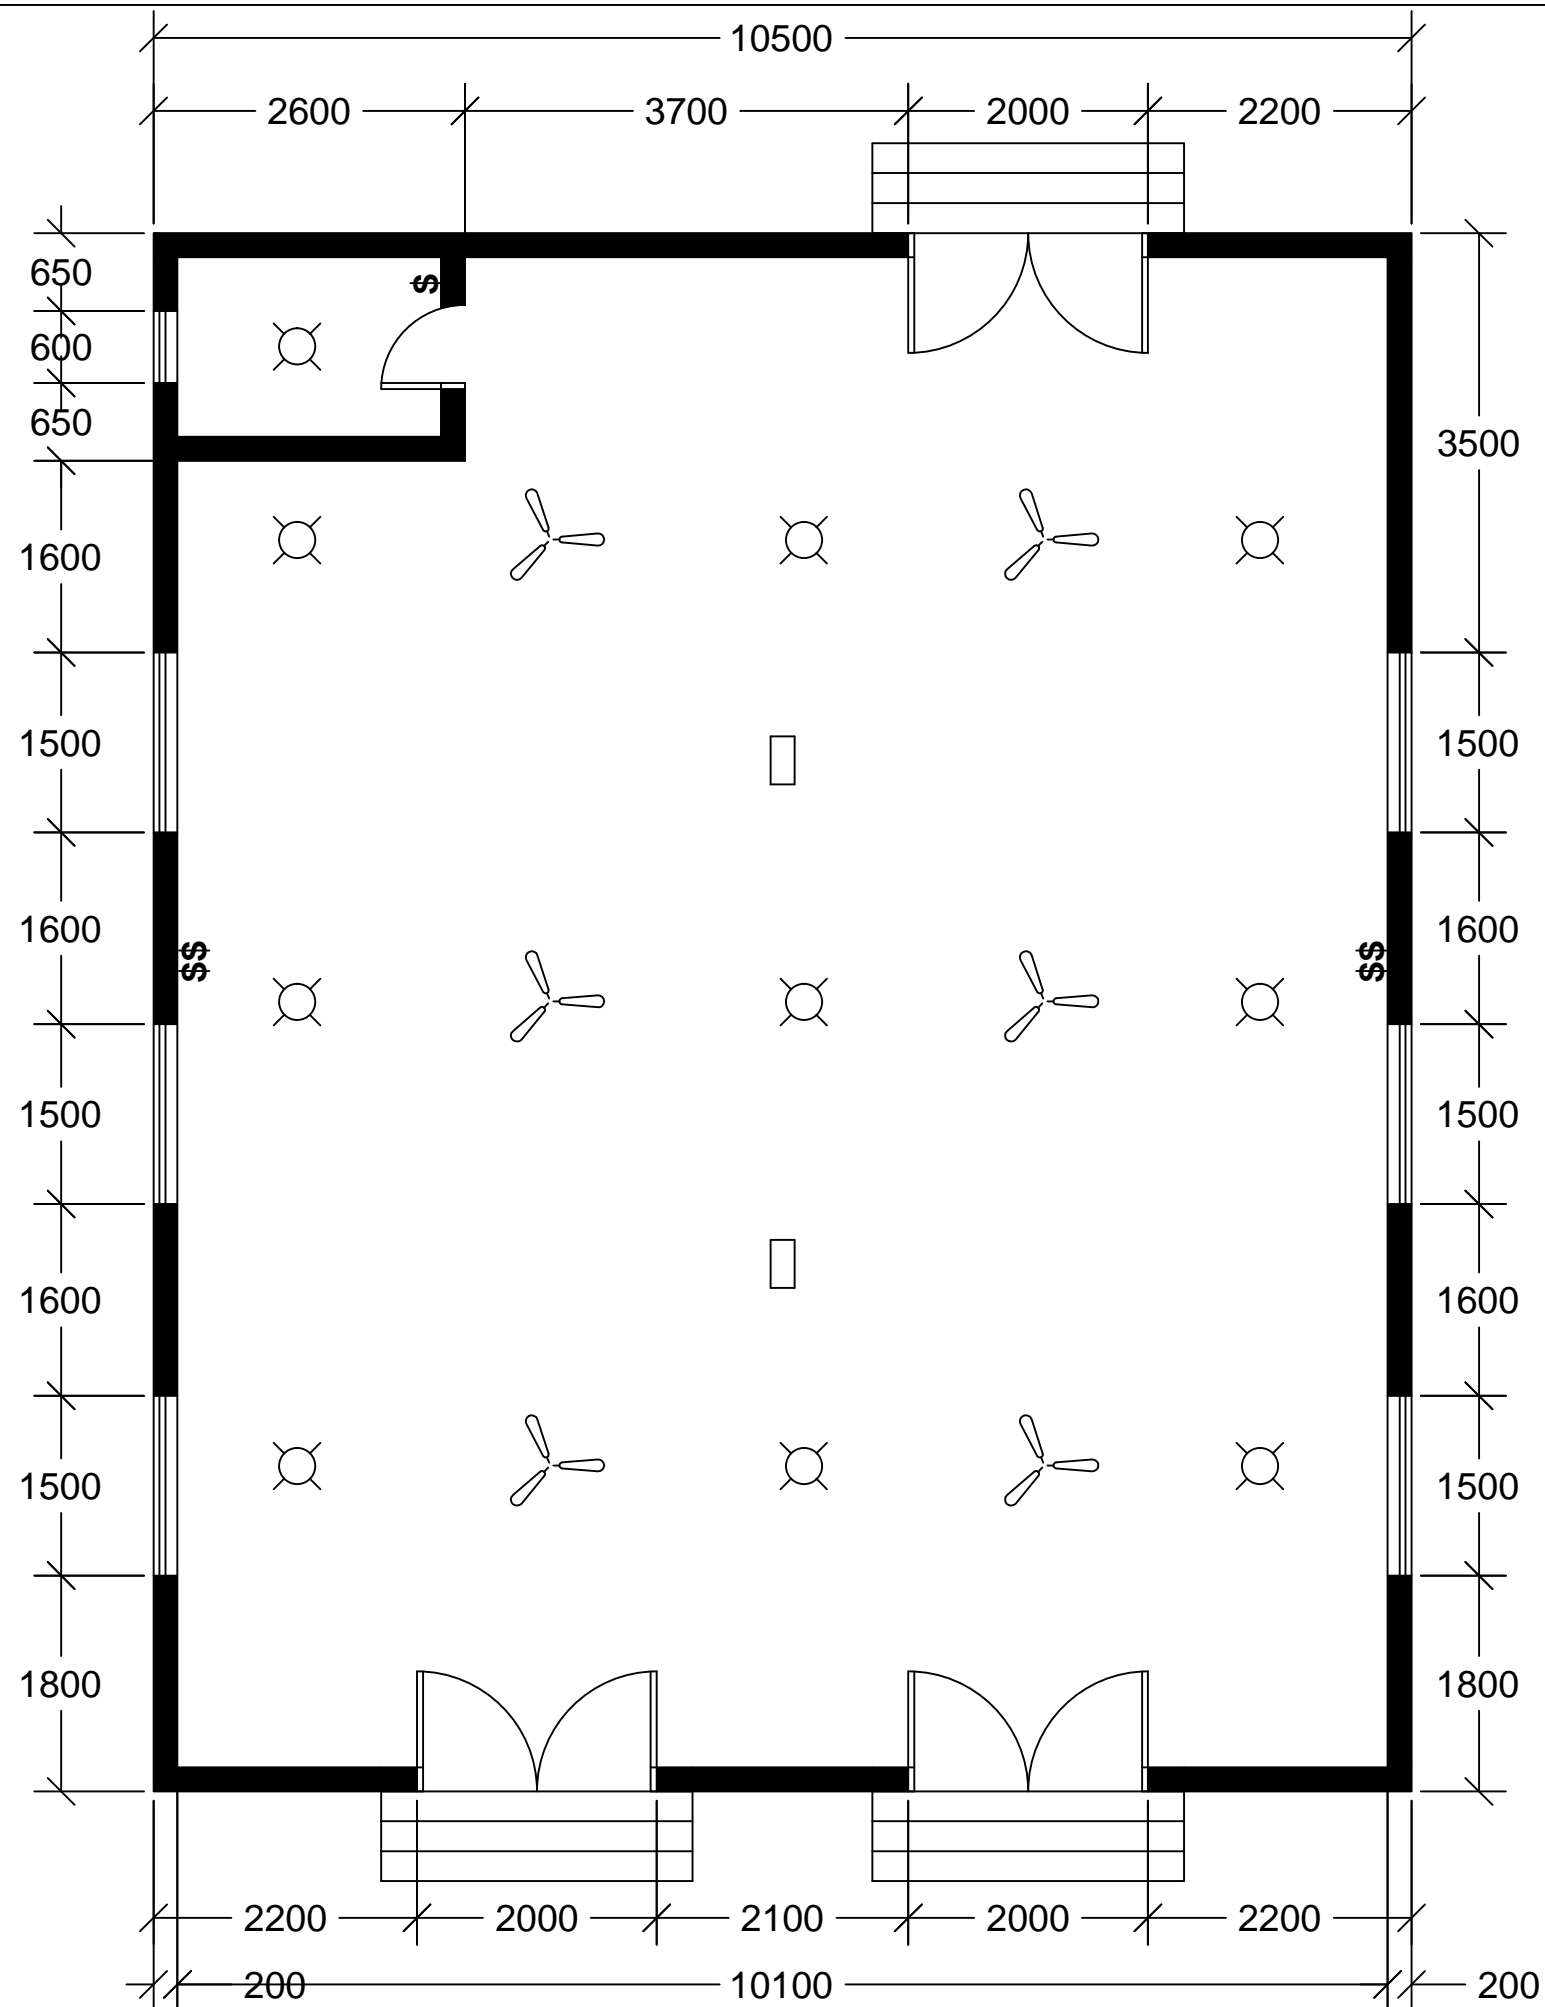

ELECTRIC PLAN LAYOUT
Scale: 1:100

Client:

1. All levels and dimensions to be checked on site before any building work commence
2. All works to be strictly in accordance to with standard specification and notes
3. walls below 200mm to be reinforced with hoop iron at every alternate course.
4. This drawing is to be read in conjunction with specifications and all other relevant drawings

Client:

Nis - Foundation

project Name:

Reconstruction of Lasanod hospital

Drawing title:

Drawing title:

prepared by:

XXXXXX

checked by:

XXXXXX

Scale:

1:100


Date:

Feb - 2024


Drawing no:

0001

Revision:

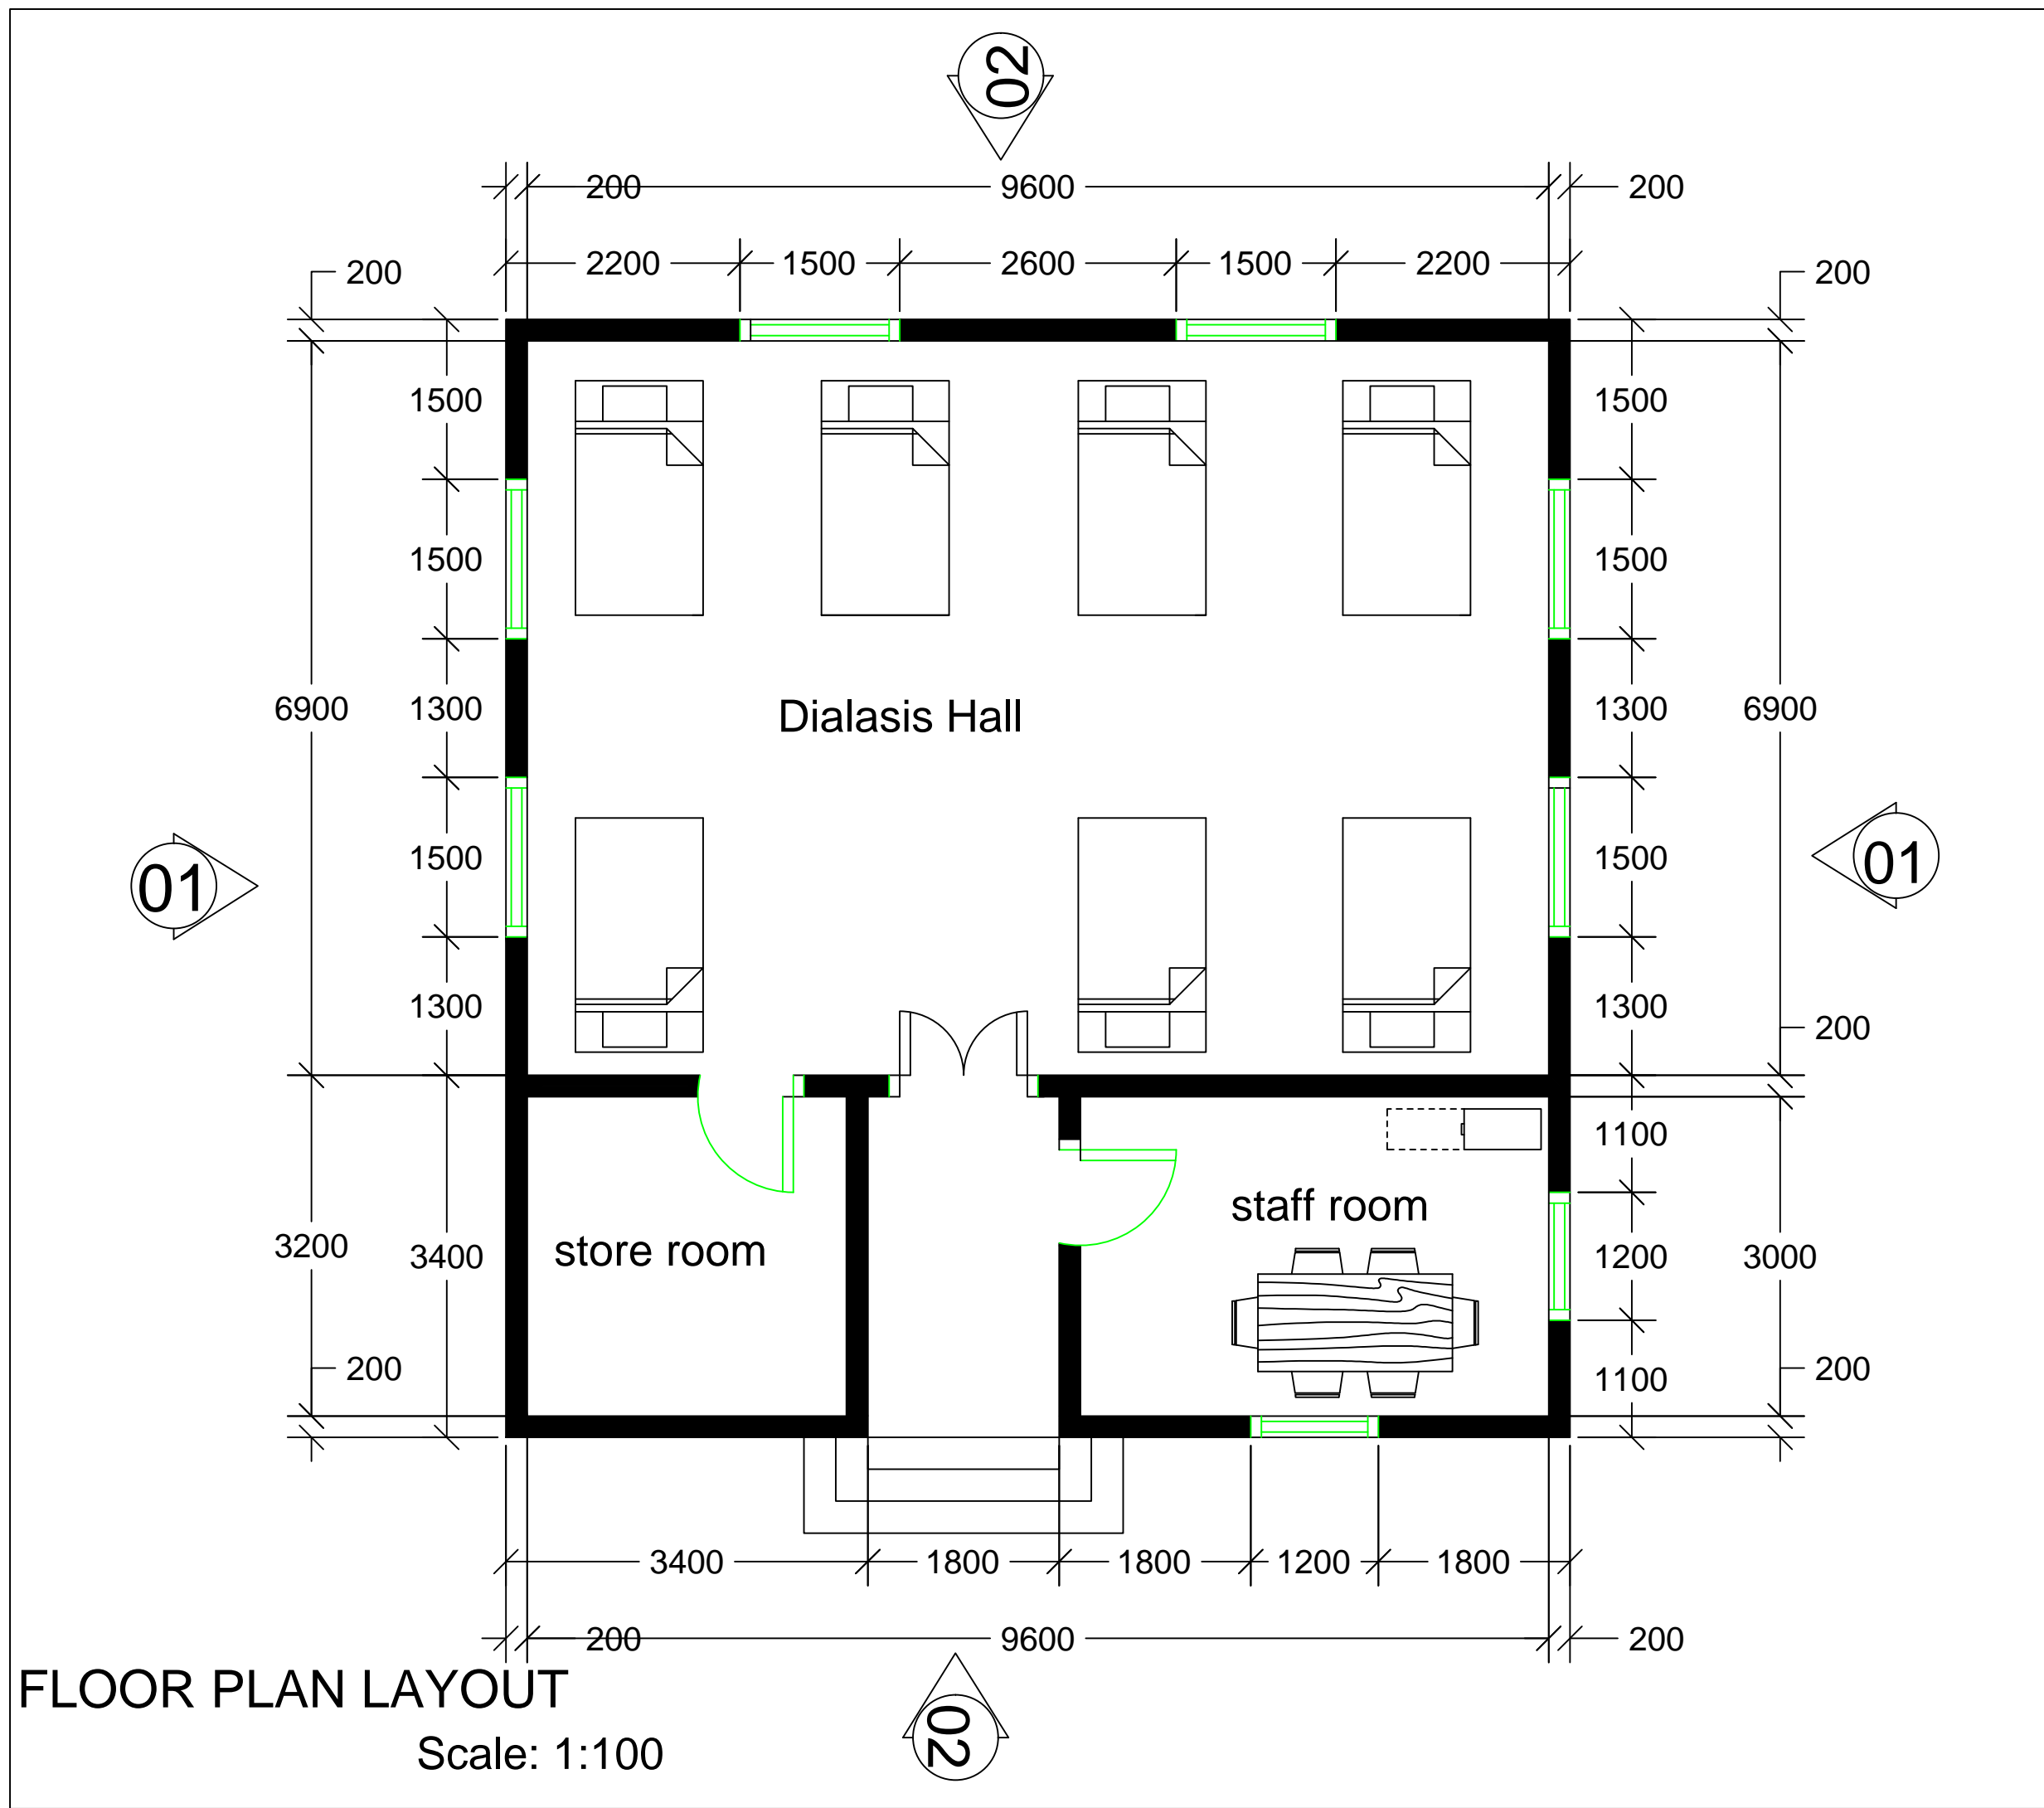

Client: <div>1. All levels and dimensions to be checked on site before any building work commence</div> <div>2.All works to be strictly in accordance to with standard specification and notes</div> <div>3. walls below 200mm to be reinforced with hoop iron at every alternate course.</div> <div>4. This drawing is to be read in conjunction with specifications and all other relevant drawings</div>	
Client: <div>Nis - Foundation</div>	
project Name: <div>Reconstruction of Lasanod hospital</div>	
Drawing title: <div>Drawing title:</div>	
prepered by: <div>XXXXXX</div>	checked by: <div>XXXXXX</div>
Scale: <div>1:100</div>	Date: <div>Feb - 2024</div>
Drawing no: <div>0001</div>	Revision:

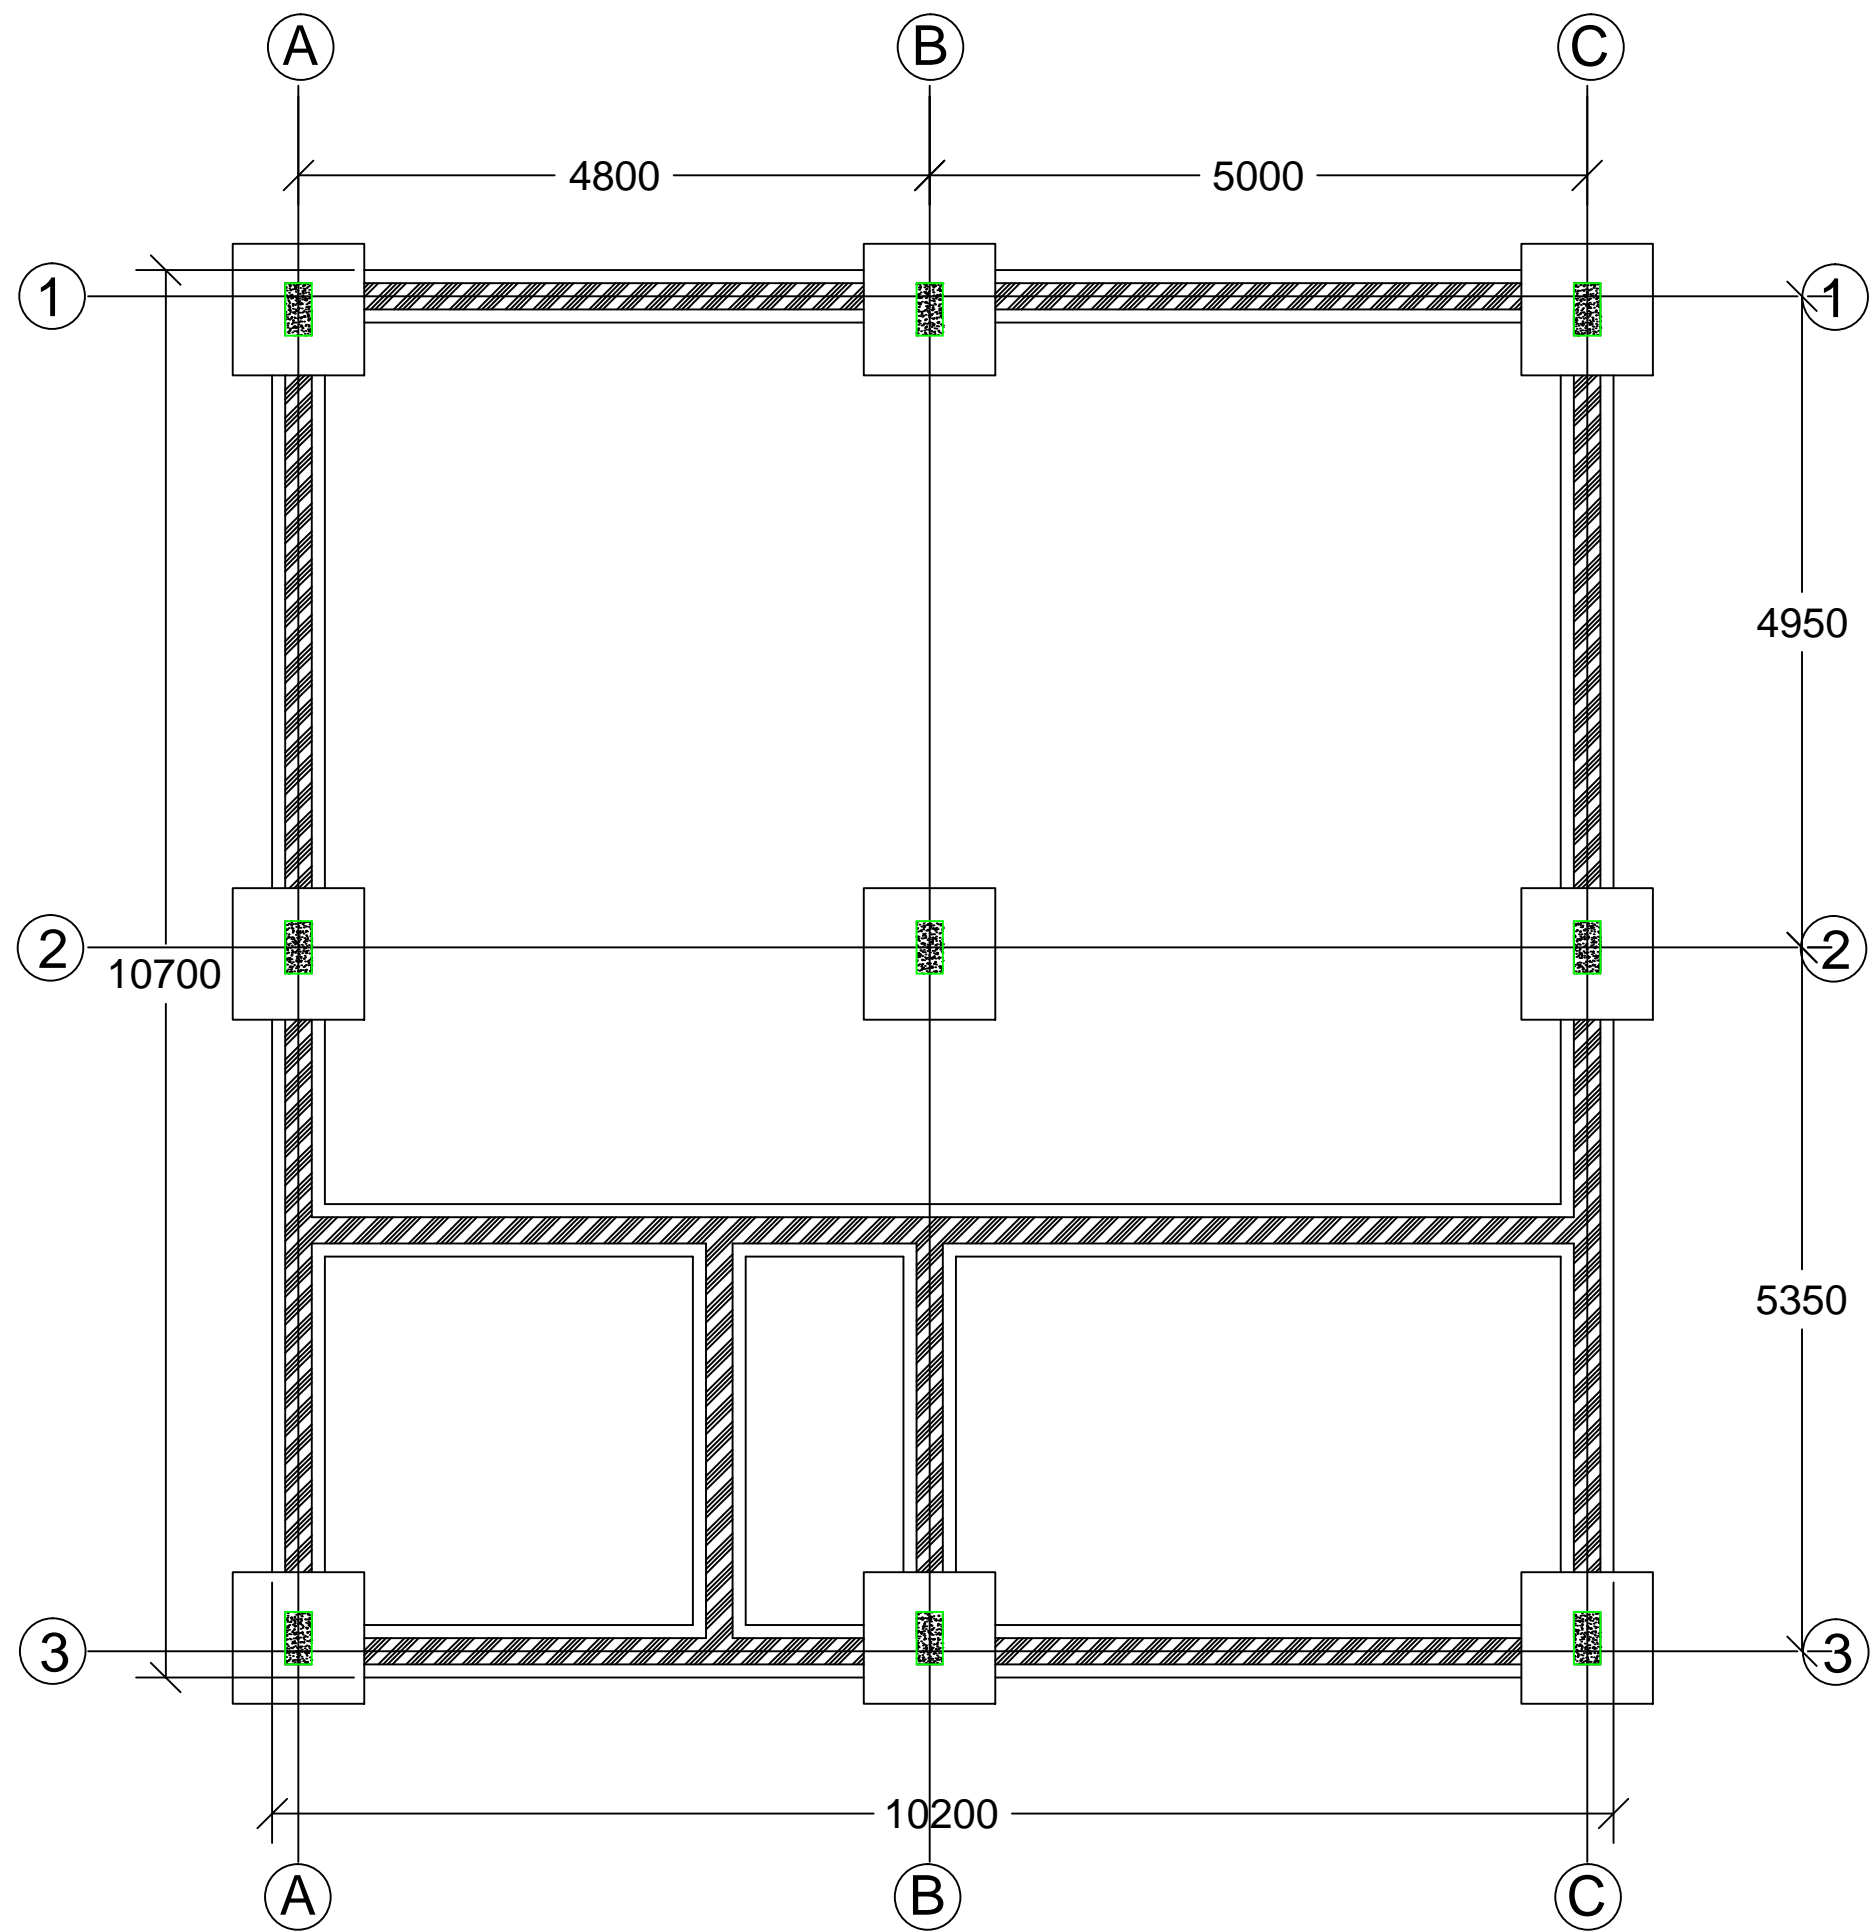

FOUNDATION LAYOUT
Scale: 1:100

Client:

1. All levels and dimensions to be checked on site before any building work commence
2. All works to be strictly in accordance to with standard specification and notes
3. walls below 200mm to be reinforced with hoop iron at every alternate course.
4. This drawing is to be read in conjunction with specifications and all other relevant drawings

Client:

Nis - Foundation

project Name:

Reconstruction of Lasanod hospital

Drawing title:

Drawing title:

prepared by:
XXXXXX



checked by:
XXXXXX

Scale:
1:100

Date:
Feb - 2024

Drawing no:
0001


Revision:

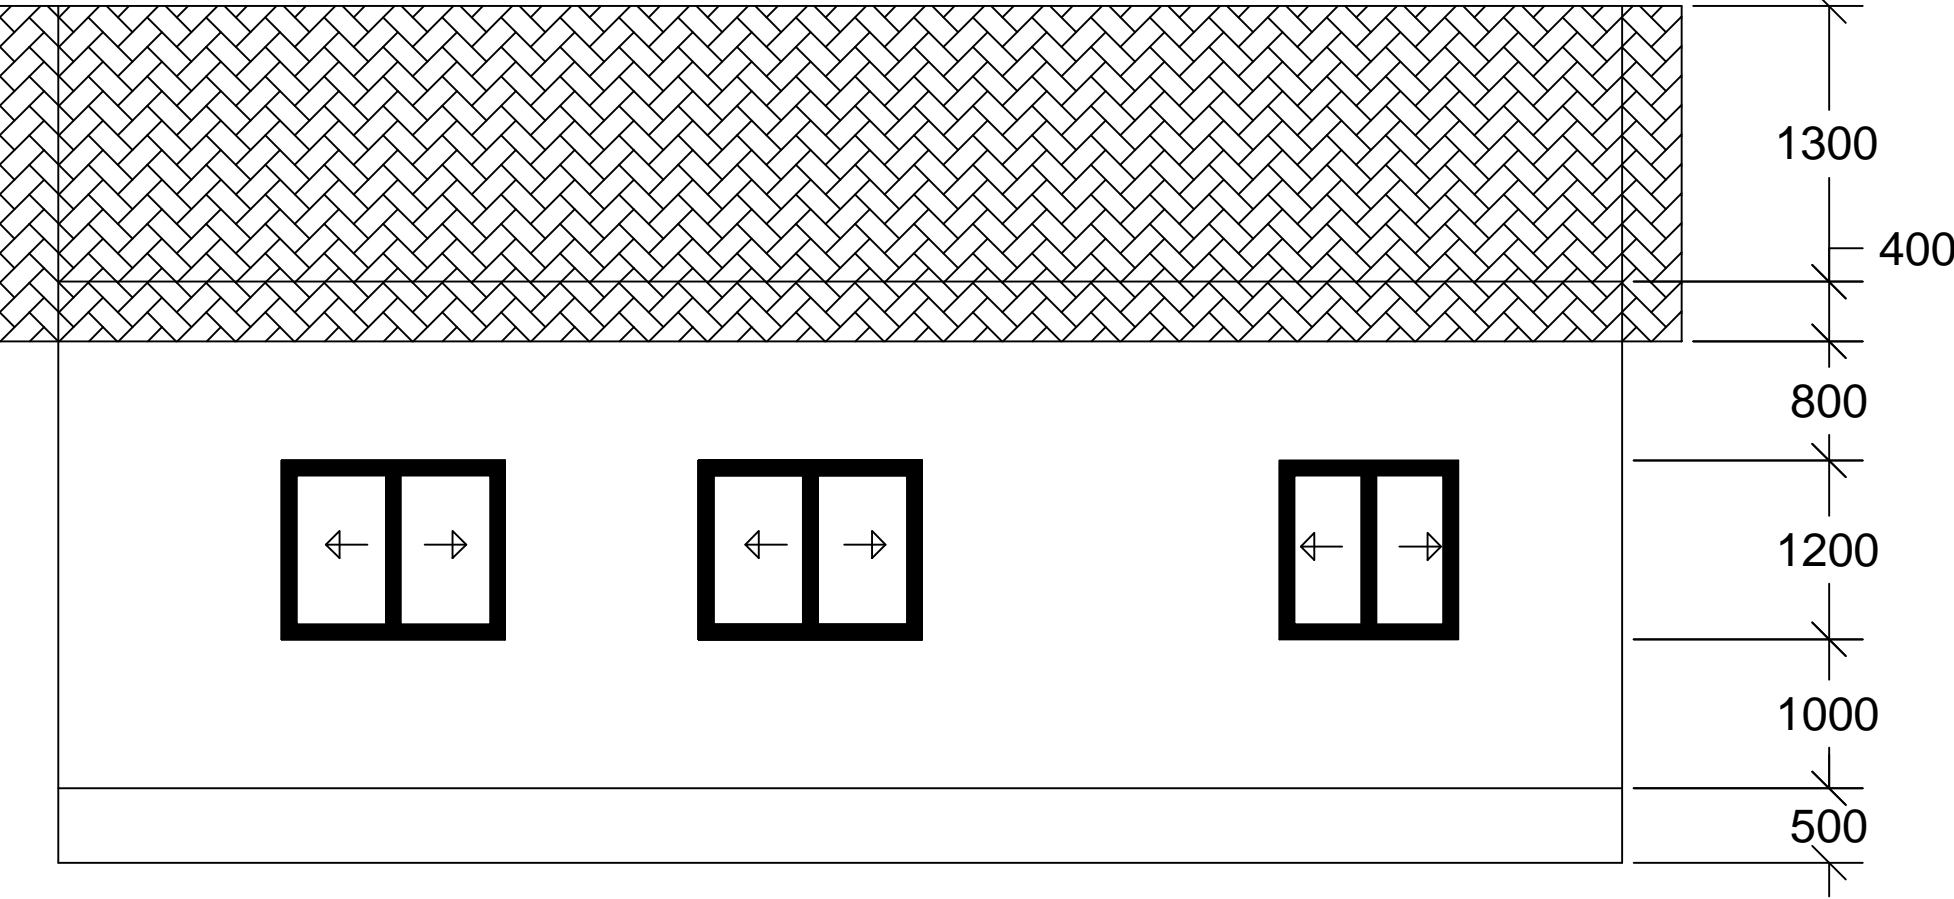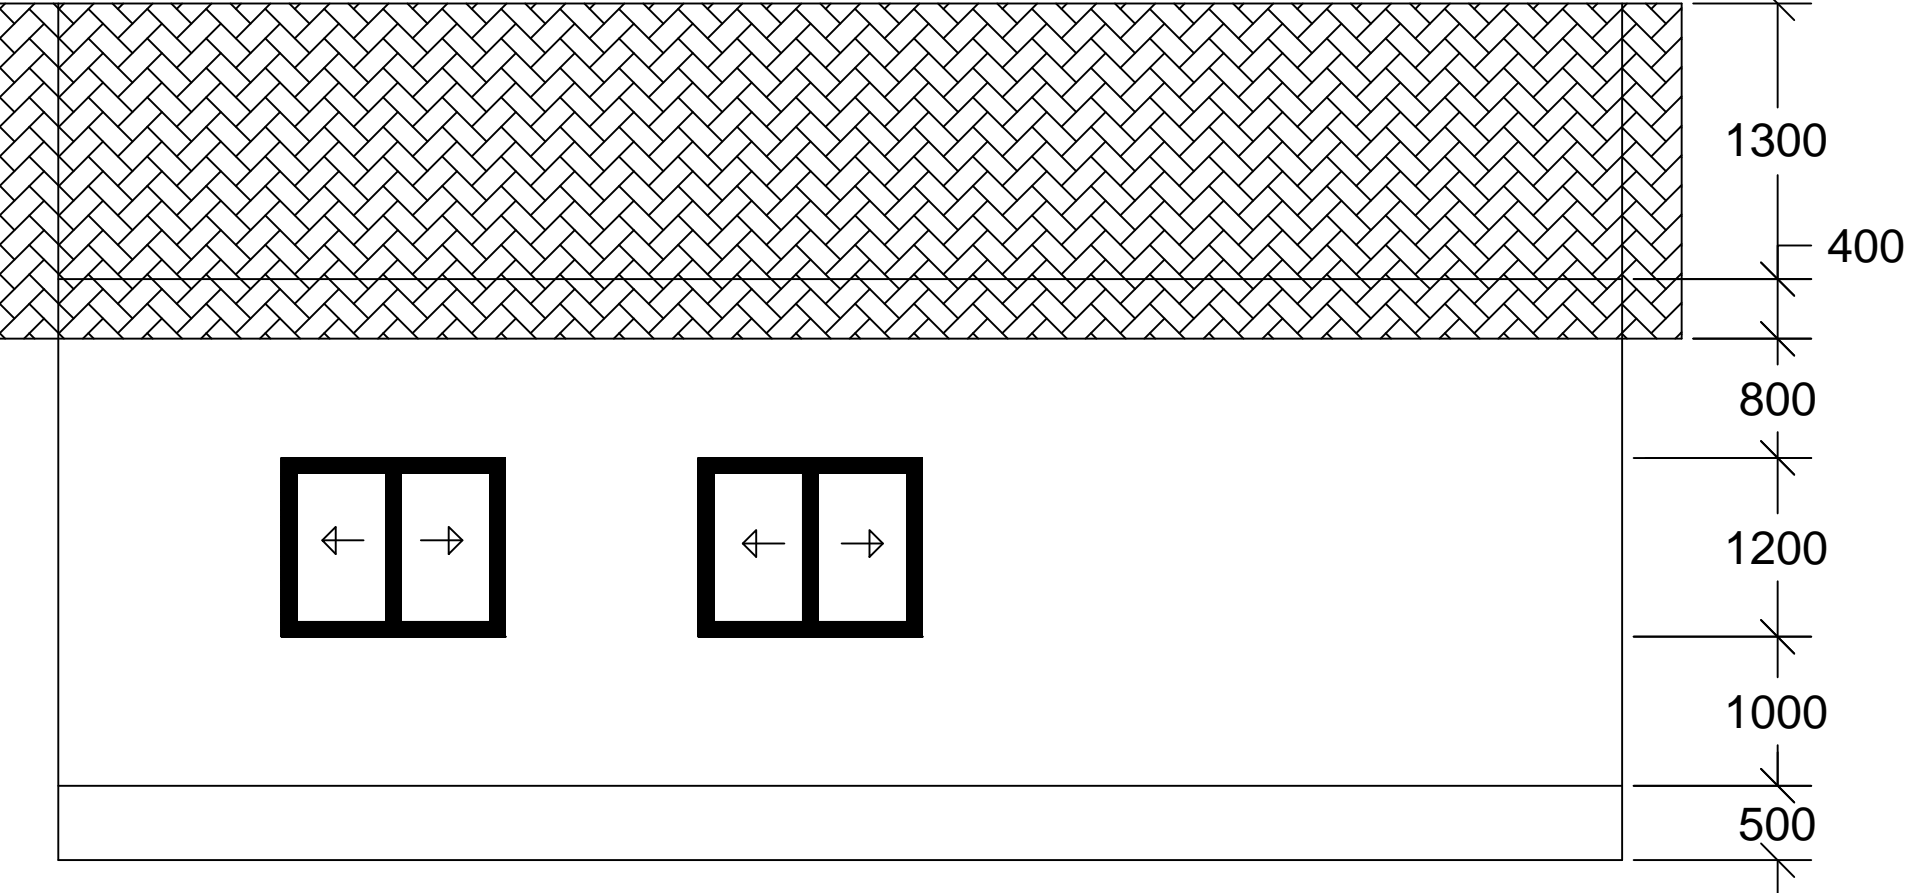

Elevation view 01
Scale: 1:100

- Client:**
- 1. All levels and dimensions to be checked on site before any building work commence
 - 2.All works to be strictly in accordance to with standard specification and notes
 - 3. walls below 200mm to be reinforced with hoop iron at every alternate course.
 - 4. This drawing is to be read in conjunction with specifications and all other relevant drawings


Client:	
Nis - Foundation	
project Name:	
Reconstruction of Lasanod hospital	
Drawing title:	
Drawing title:	
prepered by:	checked by:
XXXXXX	XXXXXX
Scale:	Date:
1:100	Feb - 2024
Drawing no:	Revision:
0001	

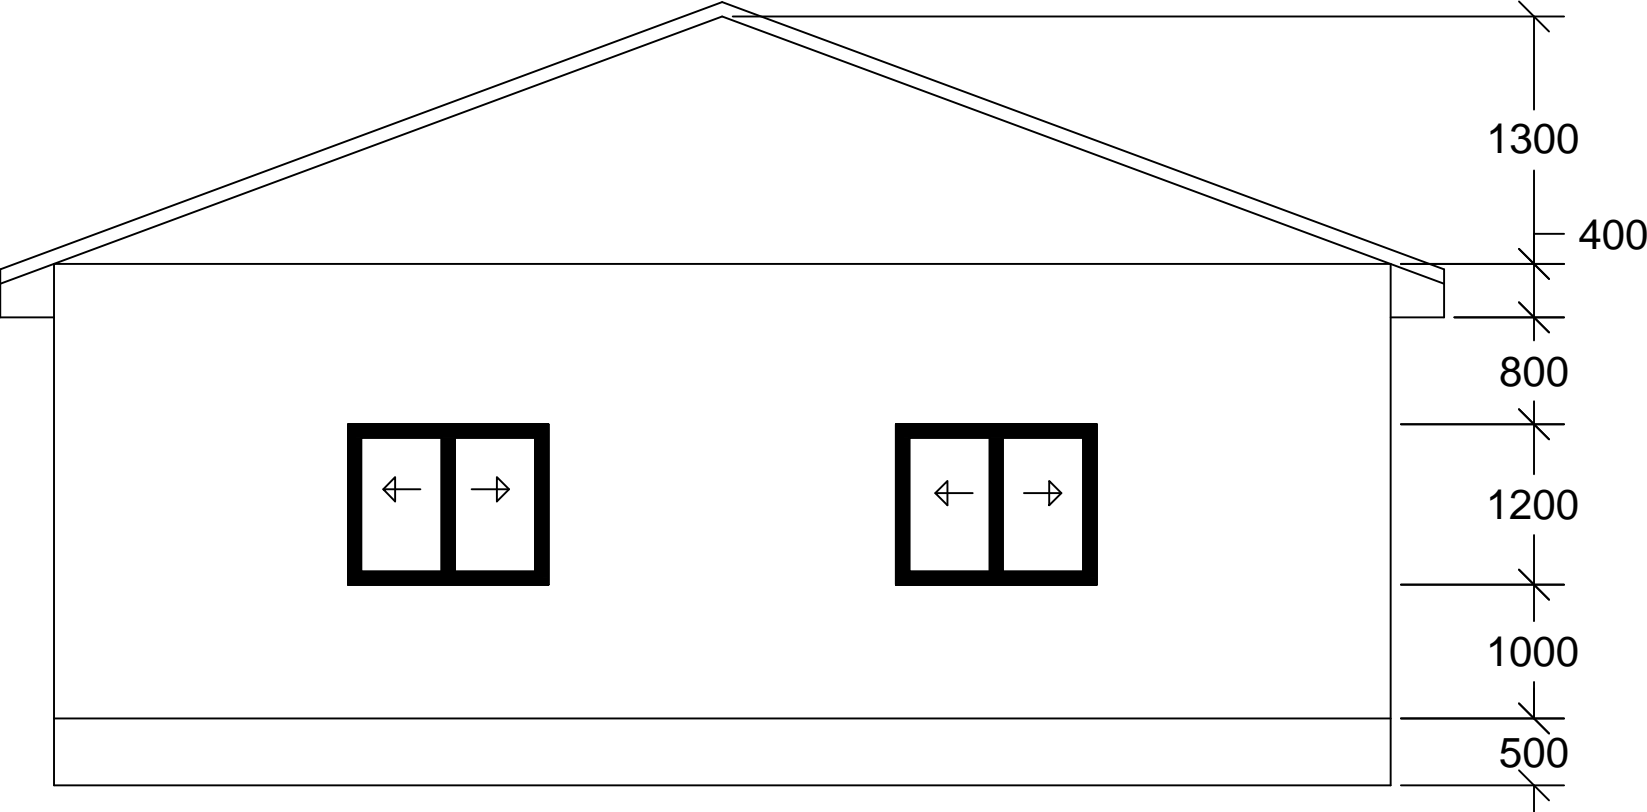

Elevation view 02
Scale: 1:100

- Client:**
- 1. All levels and dimensions to be checked on site before any building work commence
 - 2.All works to be strictly in accordance to with standard specification and notes
 - 3. walls below 200mm to be reinforced with hoop iron at every alternate course.
 - 4. This drawing is to be read in conjunction with specifications and all other relevant drawings


Client:	
Nis - Foundation	
project Name:	
Reconstruction of Lasanod hospital	
Drawing title:	
Drawing title:	
prepered by:	checked by:
XXXXXX	XXXXXX
Scale:	Date:
1:100	Feb - 2024
Drawing no:	Revision:
0001	

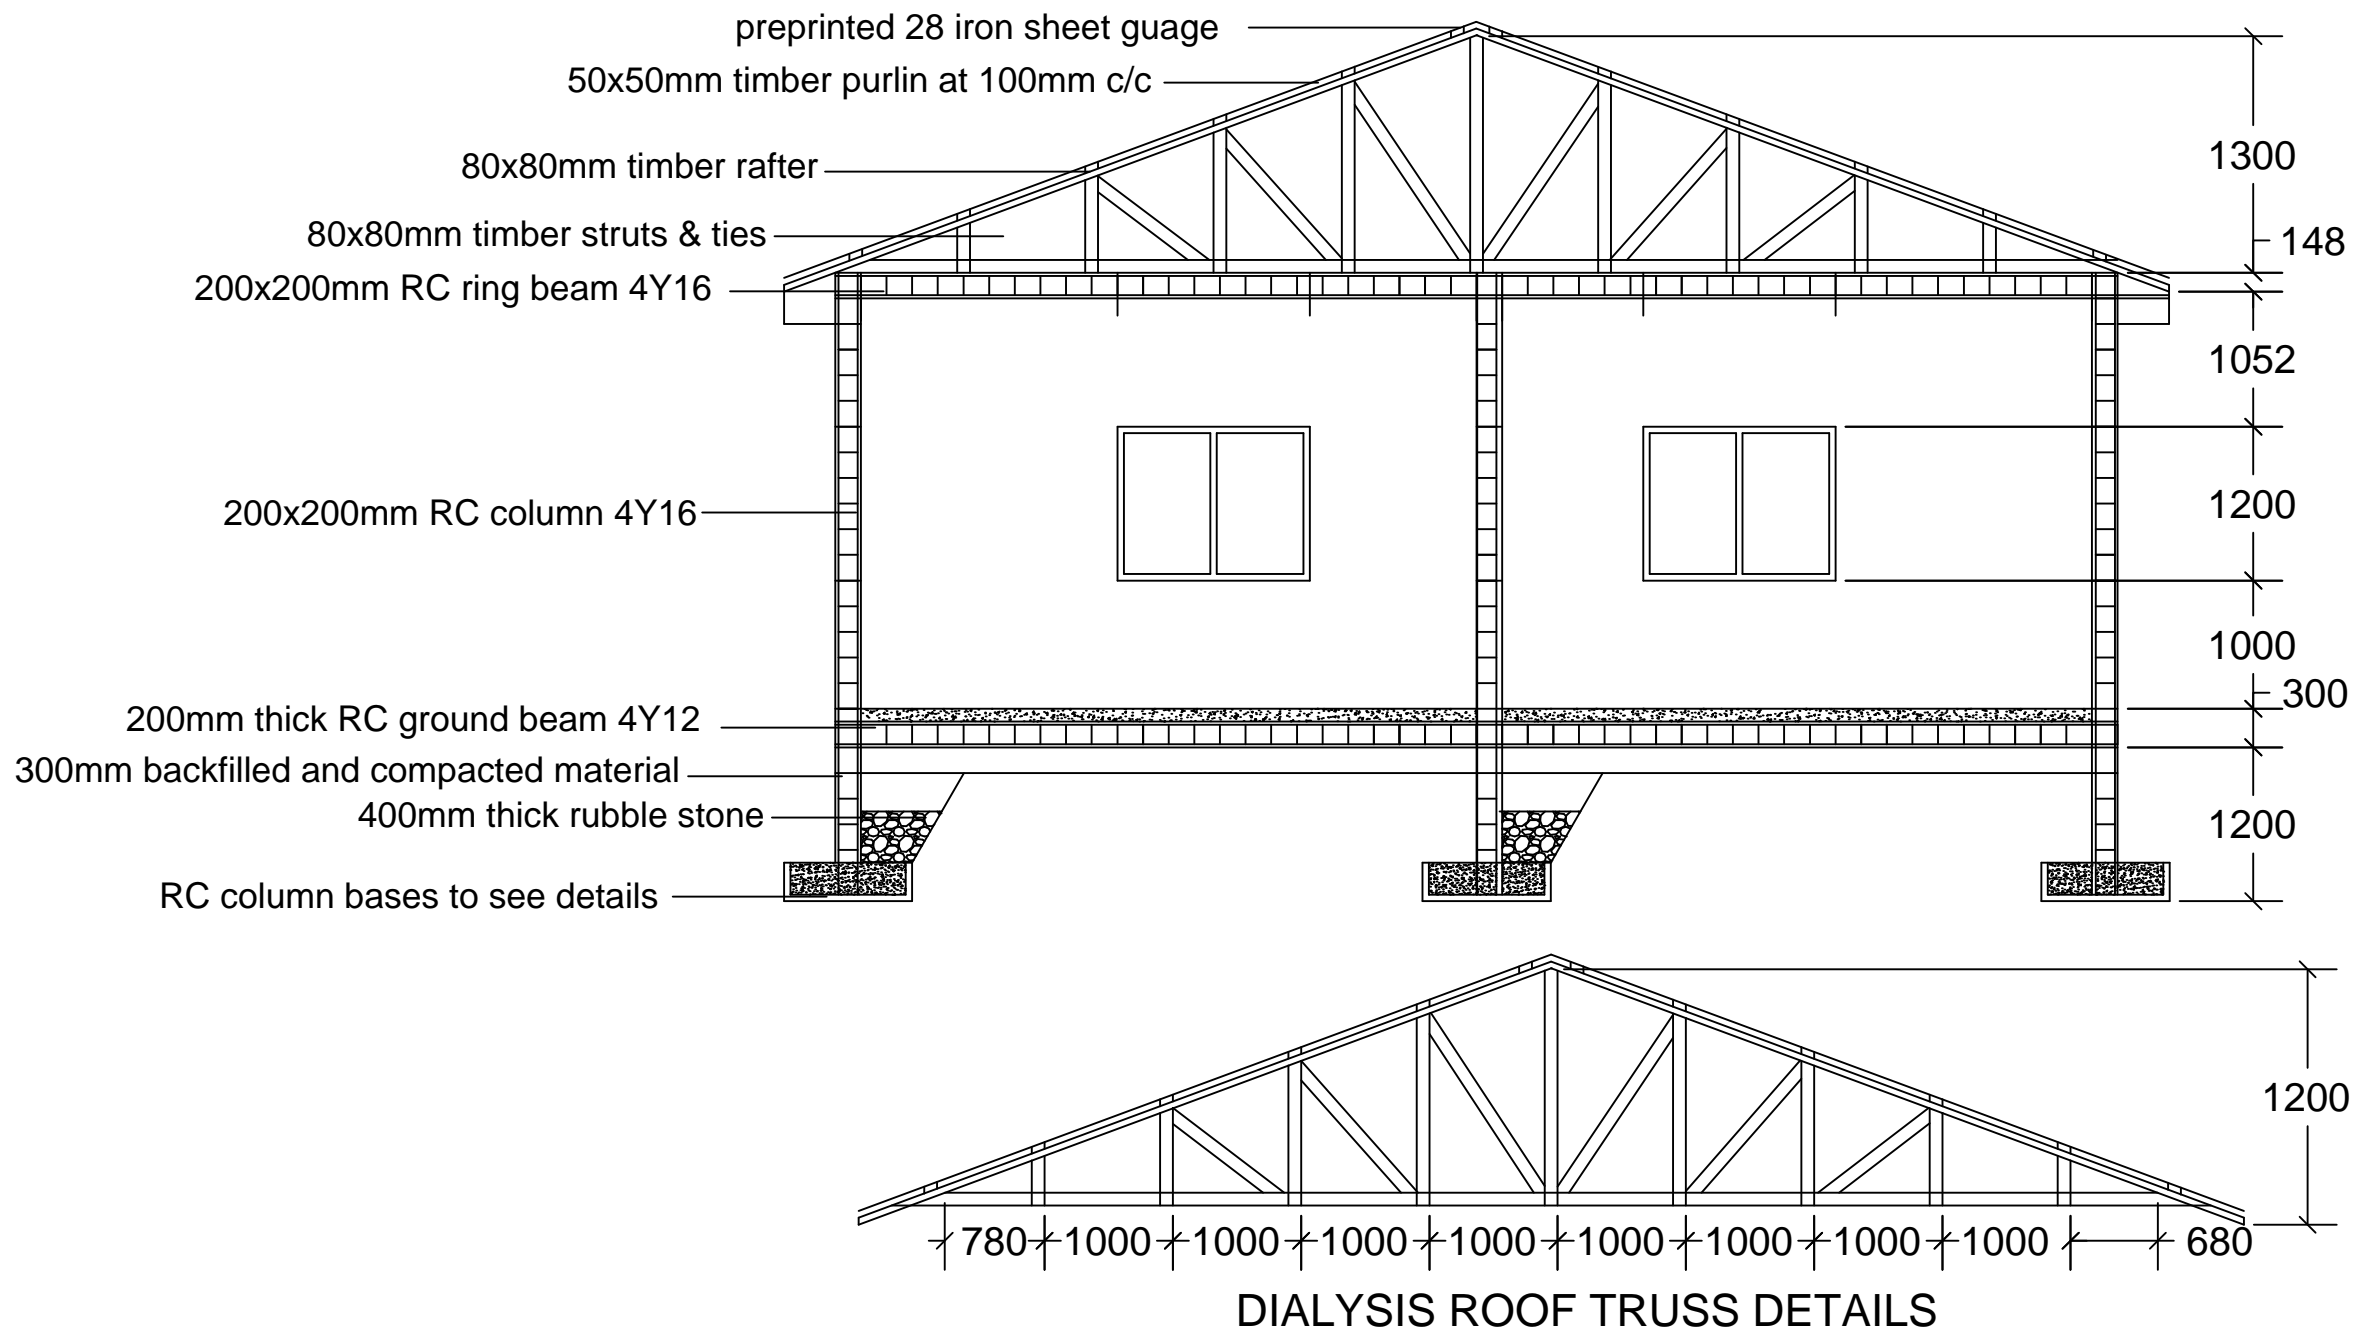

SECTION DETAILS
Scale: 1:100

- Client:
1. All levels and dimensions to be checked on site before any building work commence
 - 2.All works to be strictly in accordance to with standard specification and notes
 3. walls below 200mm to be reinforced with hoop iron at every alternate course.
 4. This drawing is to be read in conjunction with specifications and all other relevant drawings


Client:	
Nis - Foundation	
project Name:	
Reconstruction of Lasanod hospital	
Drawing title:	
Drawing title:	
prepered by:	checked by:
XXXXXX	XXXXXX
Scale:	Date:
1:100	Feb - 2024
Drawing no:	Revision:
0001	

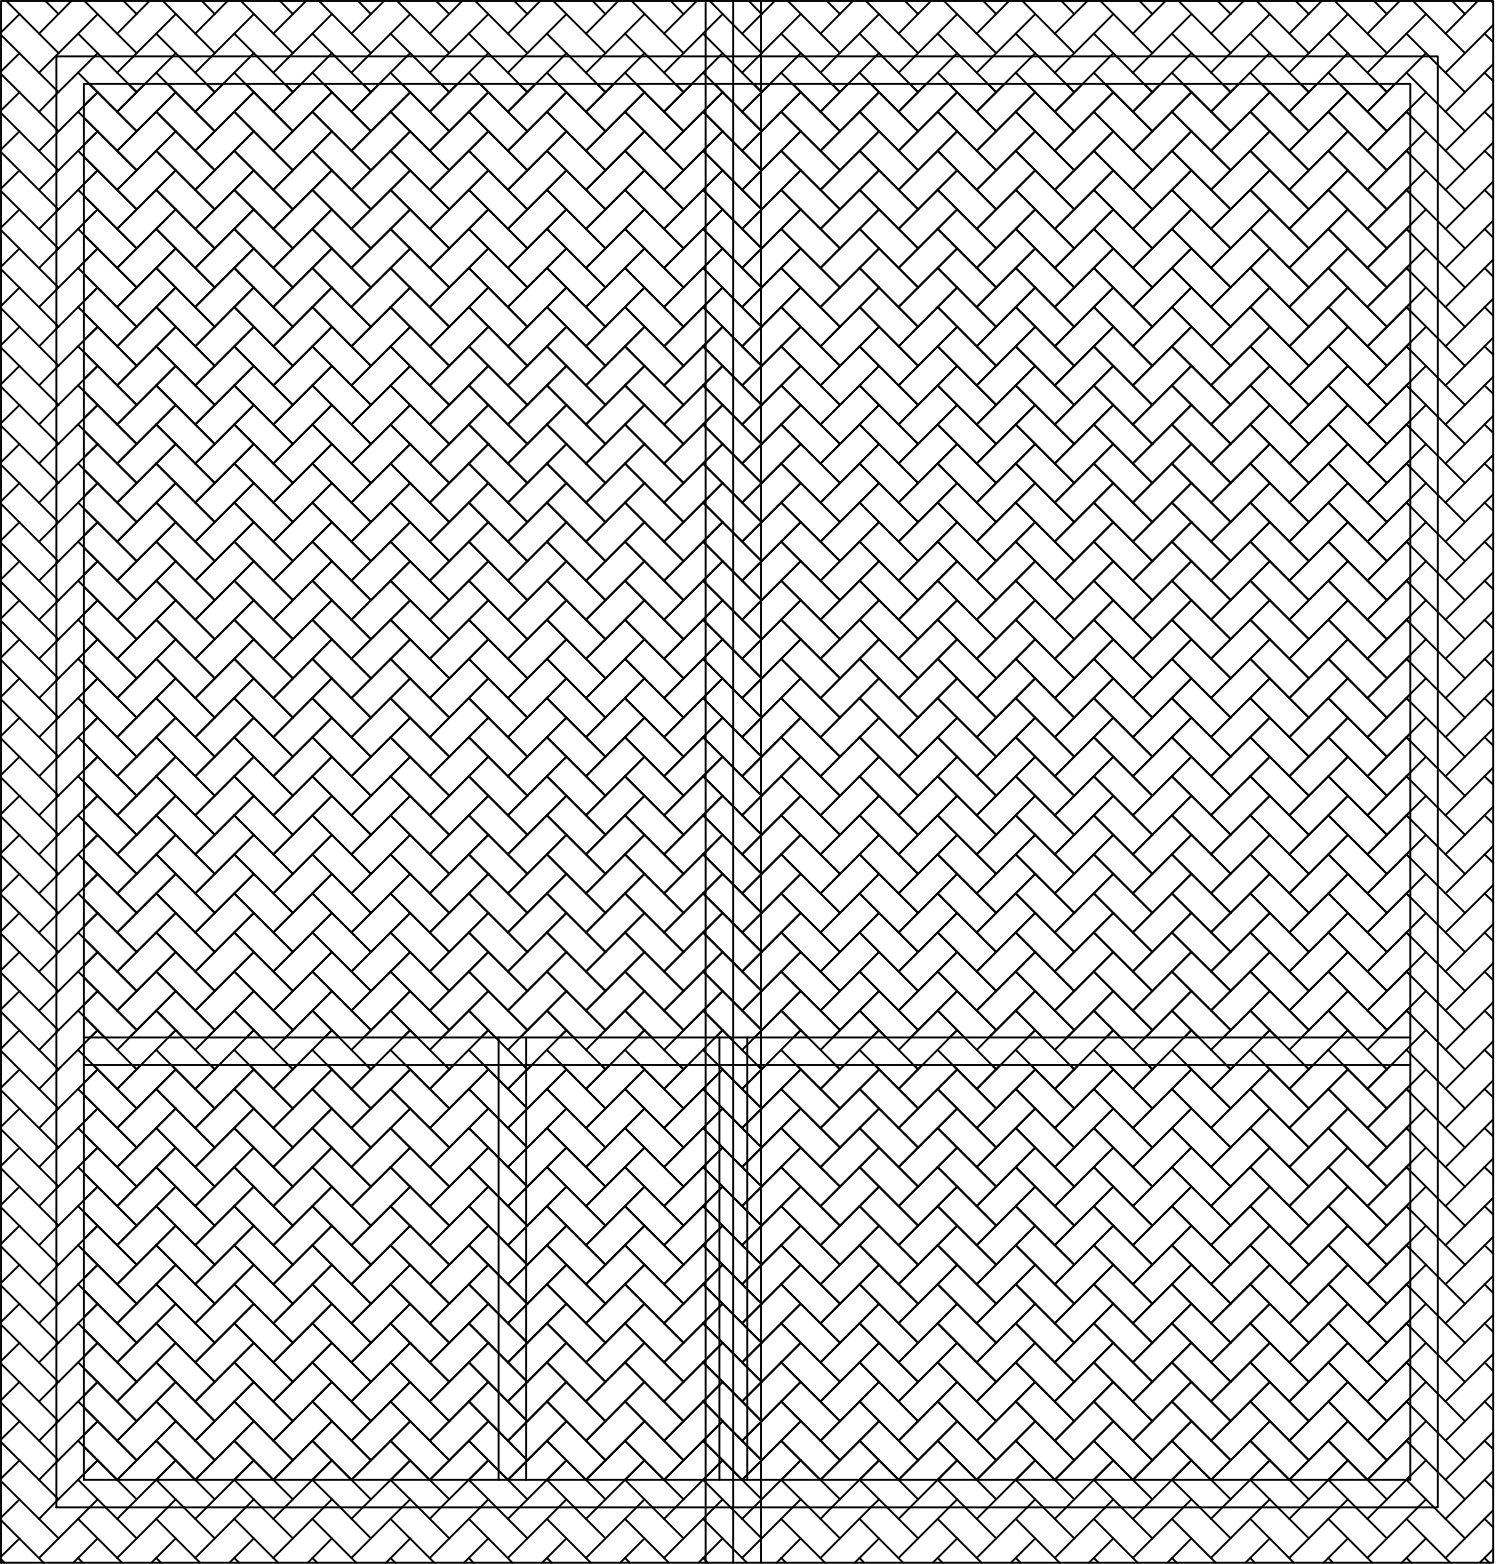

ROOF PLAN LAYOUT
Scale: 1:100

- Client:
- 1. All levels and dimensions to be checked on site before any building work commence
 - 2.All works to be strictly in accordance to with standard specification and notes
 - 3. walls below 200mm to be reinforced with hoop iron at every alternate course.
 - 4. This drawing is to be read in conjunction with specifications and all other relevant drawings

Client:	
Nis - Foundation	
project Name:	
Reconstruction of Lasanod hospital	
Drawing title:	
Drawing title:	
prepered by:	checked by:
XXXXXX	XXXXXX
Scale:	Date:
1:100	Feb - 2024
Drawing no:	Revision:
0001	

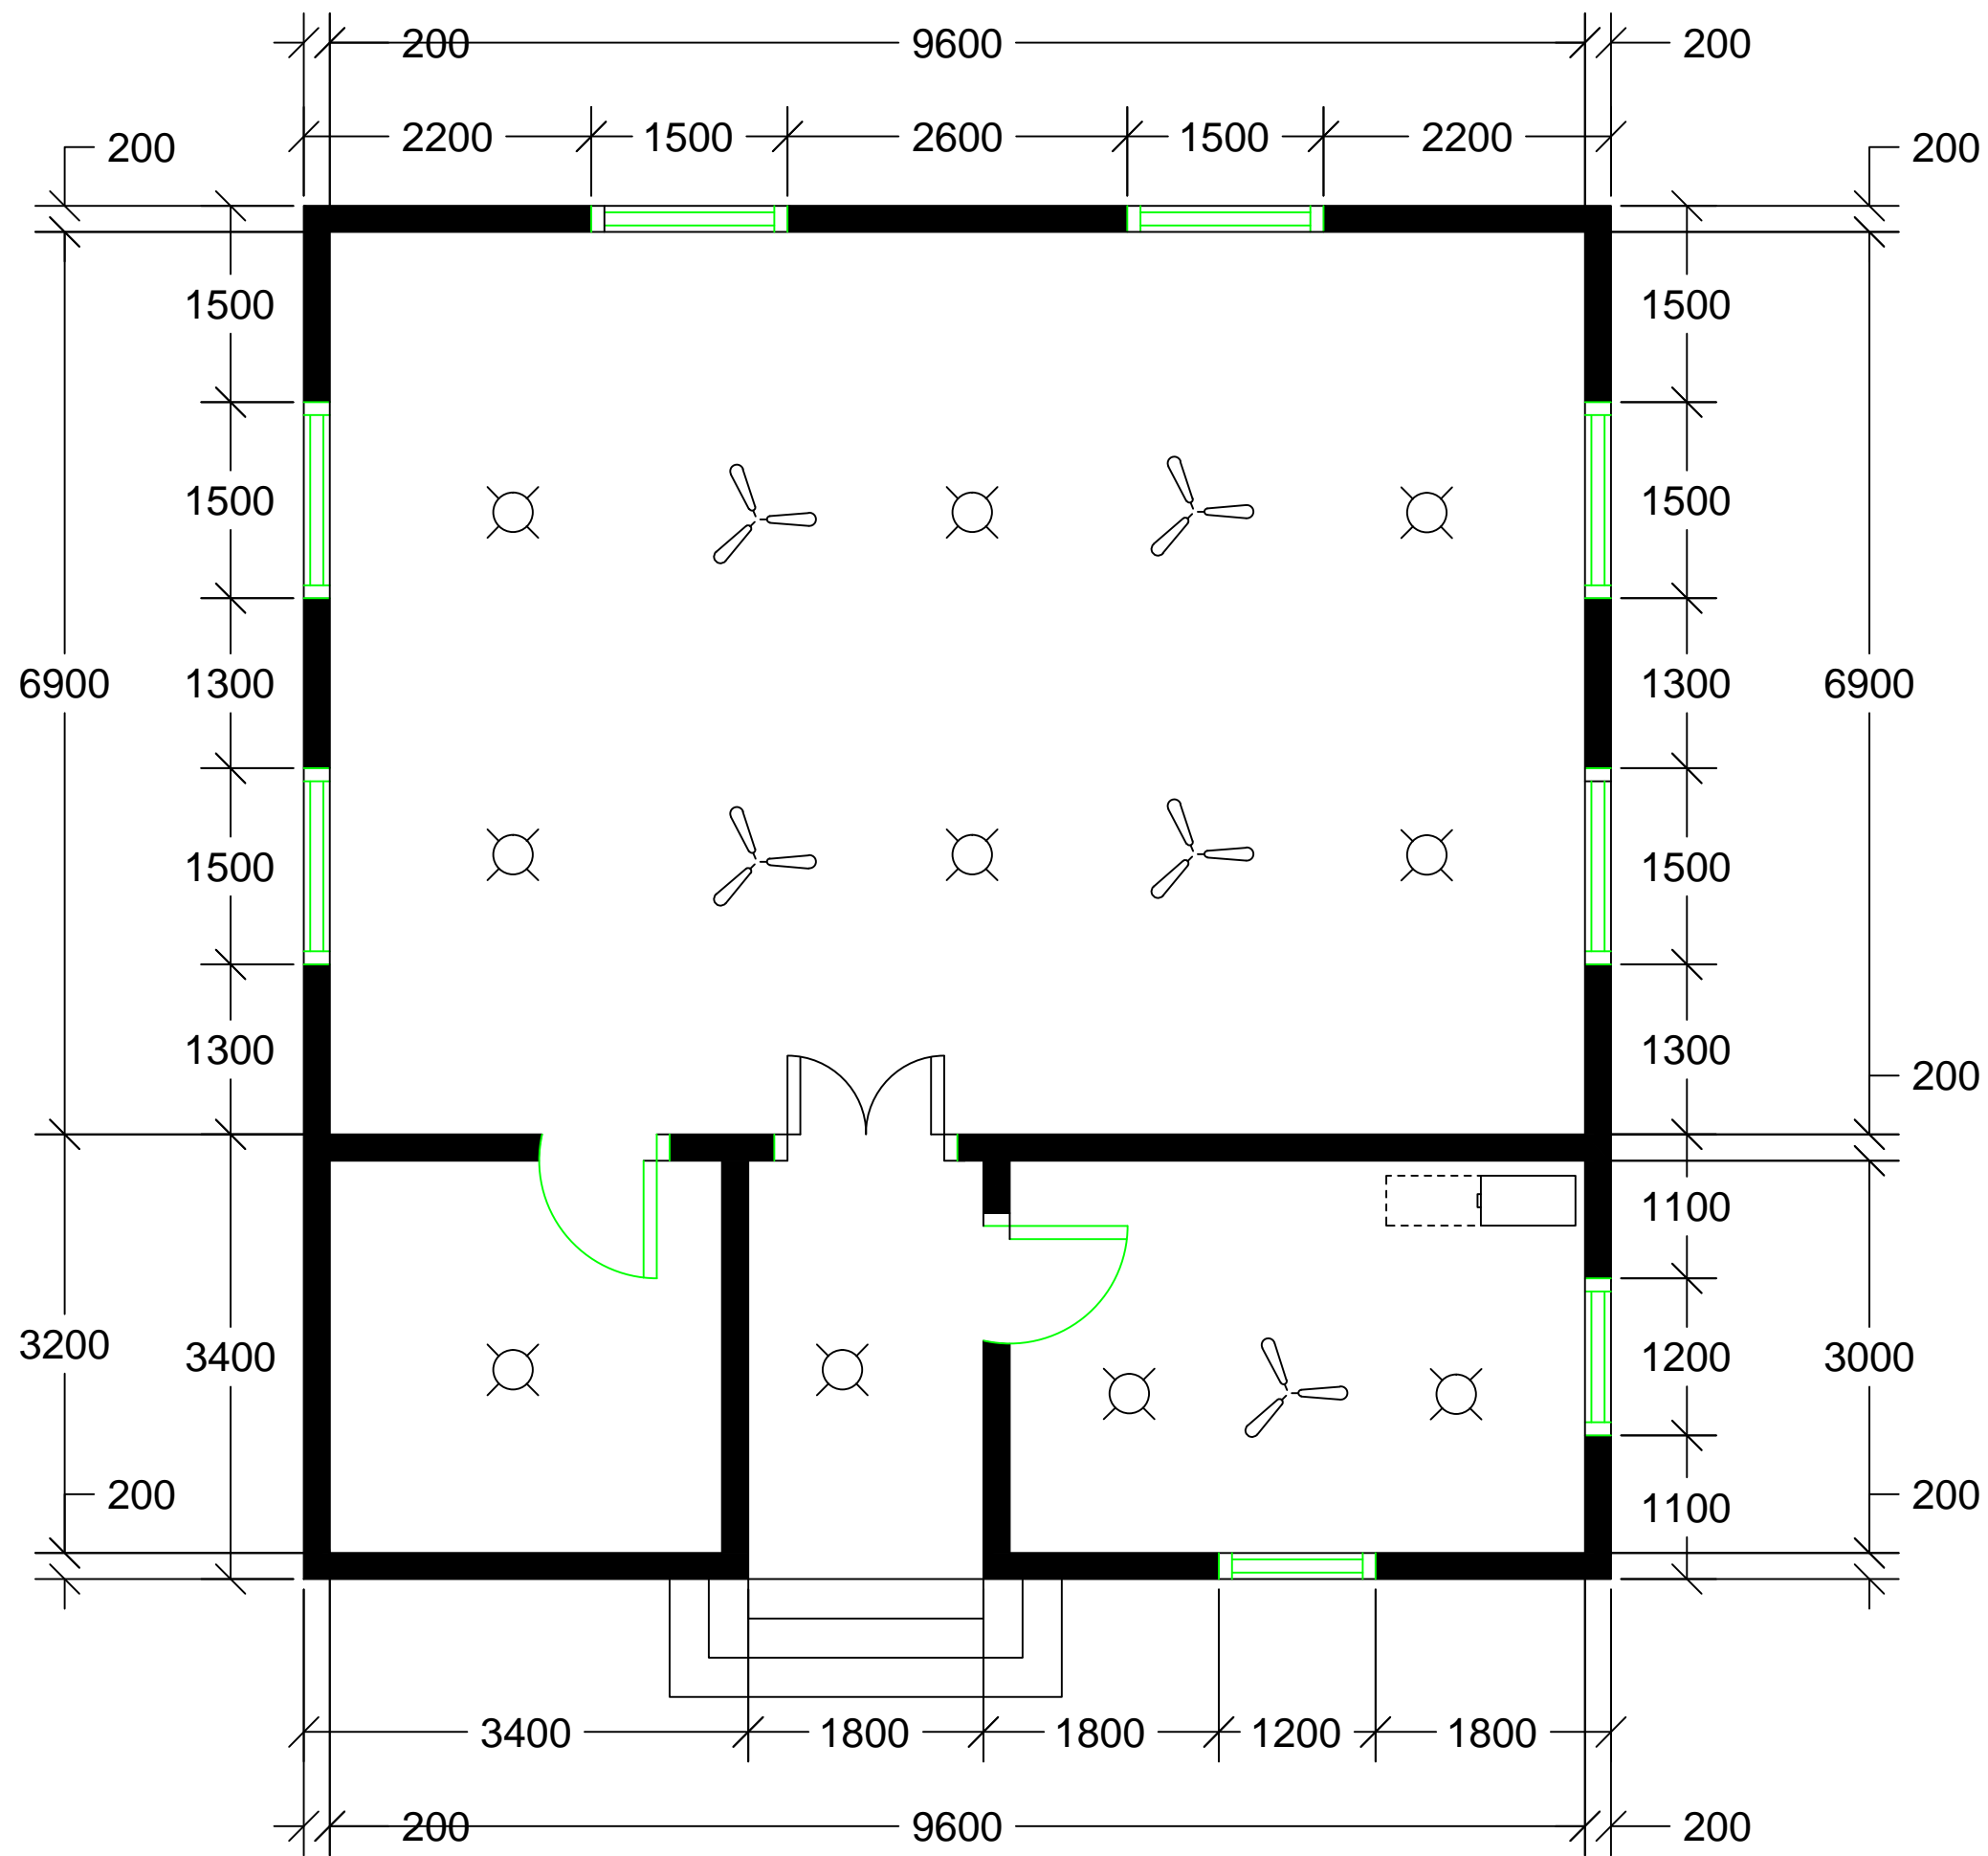

ELECTRIC PLAN LAYOUT
Scale: 1:100

Client:

1. All levels and dimensions to be checked on site before any building work commence
2. All works to be strictly in accordance to with standard specification and notes
3. walls below 200mm to be reinforced with hoop iron at every alternate course.
4. This drawing is to be read in conjunction with specifications and all other relevant drawings

Client:

Nis - Foundation

project Name:

Reconstruction of Lasanod hospital

Drawing title:

Drawing title:

prepared by:
XXXXXX


checked by:
XXXXXX

Scale:
1:100

Date:
Feb - 2024

Drawing no:
0001

Revision:

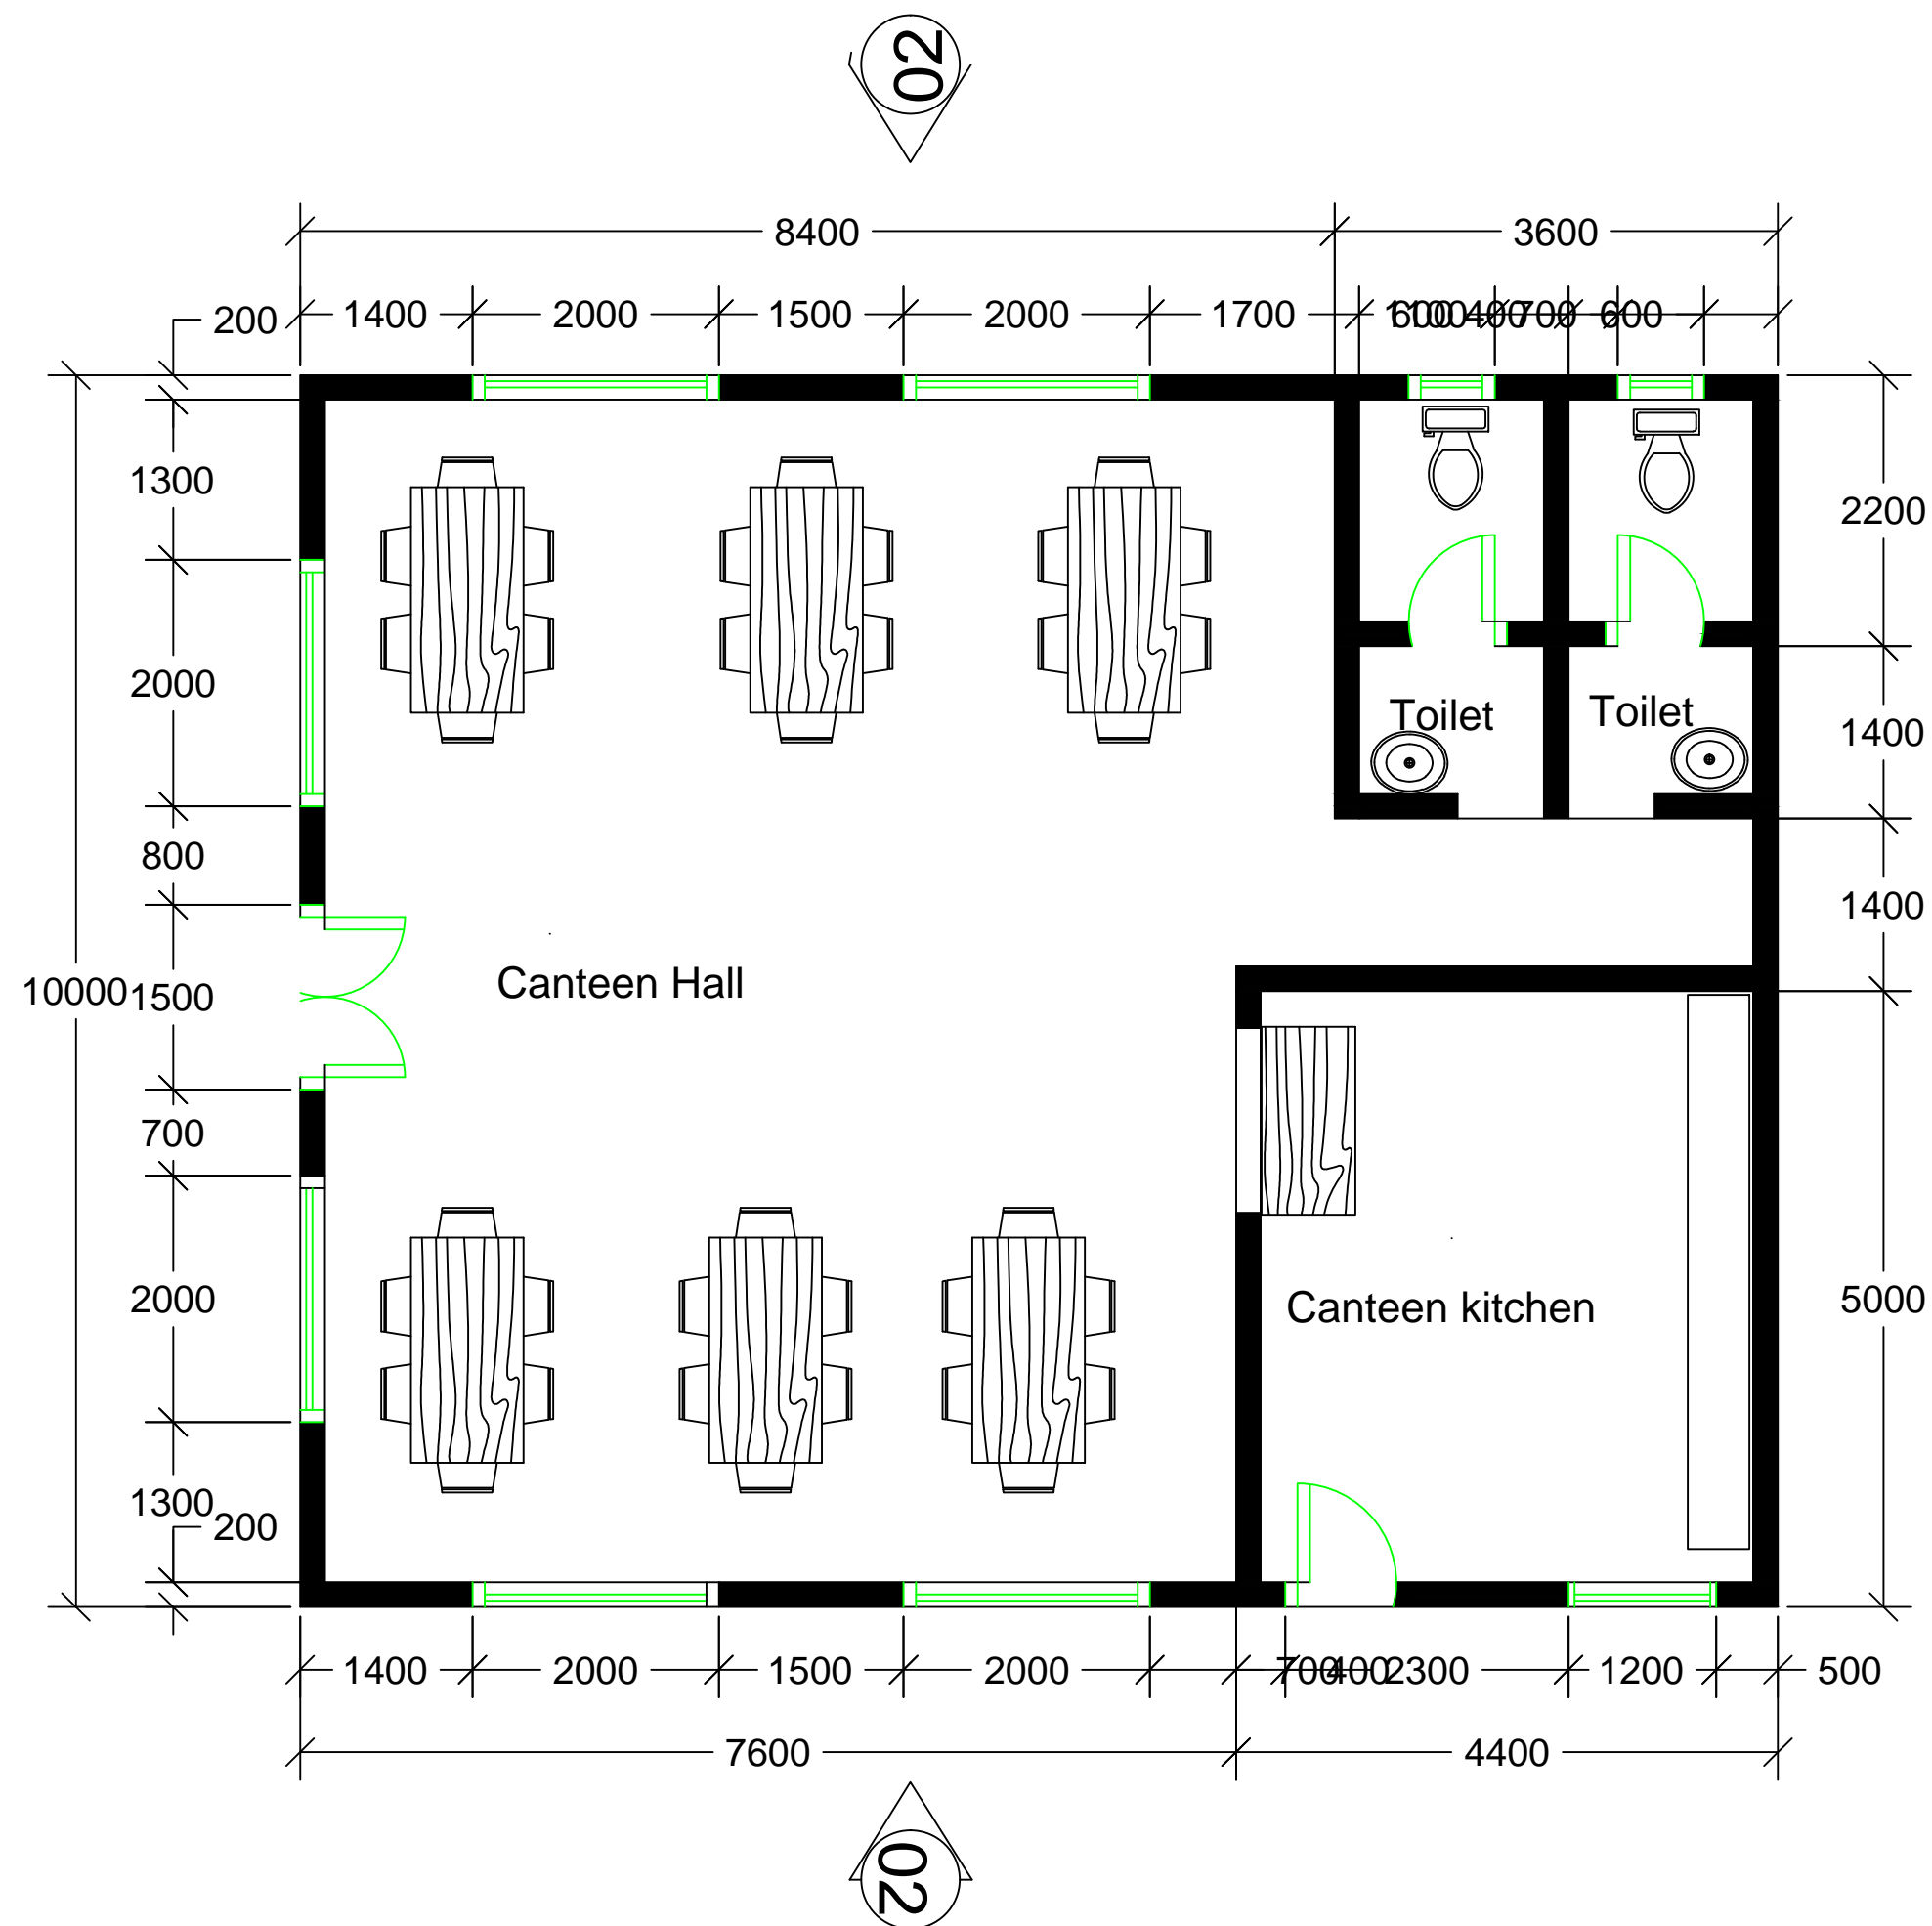

FLOOR PLAN LAYOUT
Scale: 1:100

Client:

1. All levels and dimensions to be checked on site before any building work commence
2. All works to be strictly in accordance to with standard specification and notes
3. walls below 200mm to be reinforced with hoop iron at every alternate course.
4. This drawing is to be read in conjunction with specifications and all other relevant drawings

Client:

Nis - Foundation

project Name:

Reconstruction of Lasanod hospital

Drawing title:

Drawing title:

prepared by:

XXXXXX

checked by:

XXXXXX

Scale:

1:100


Date:

Feb - 2024

Drawing no:

0001

Revision:

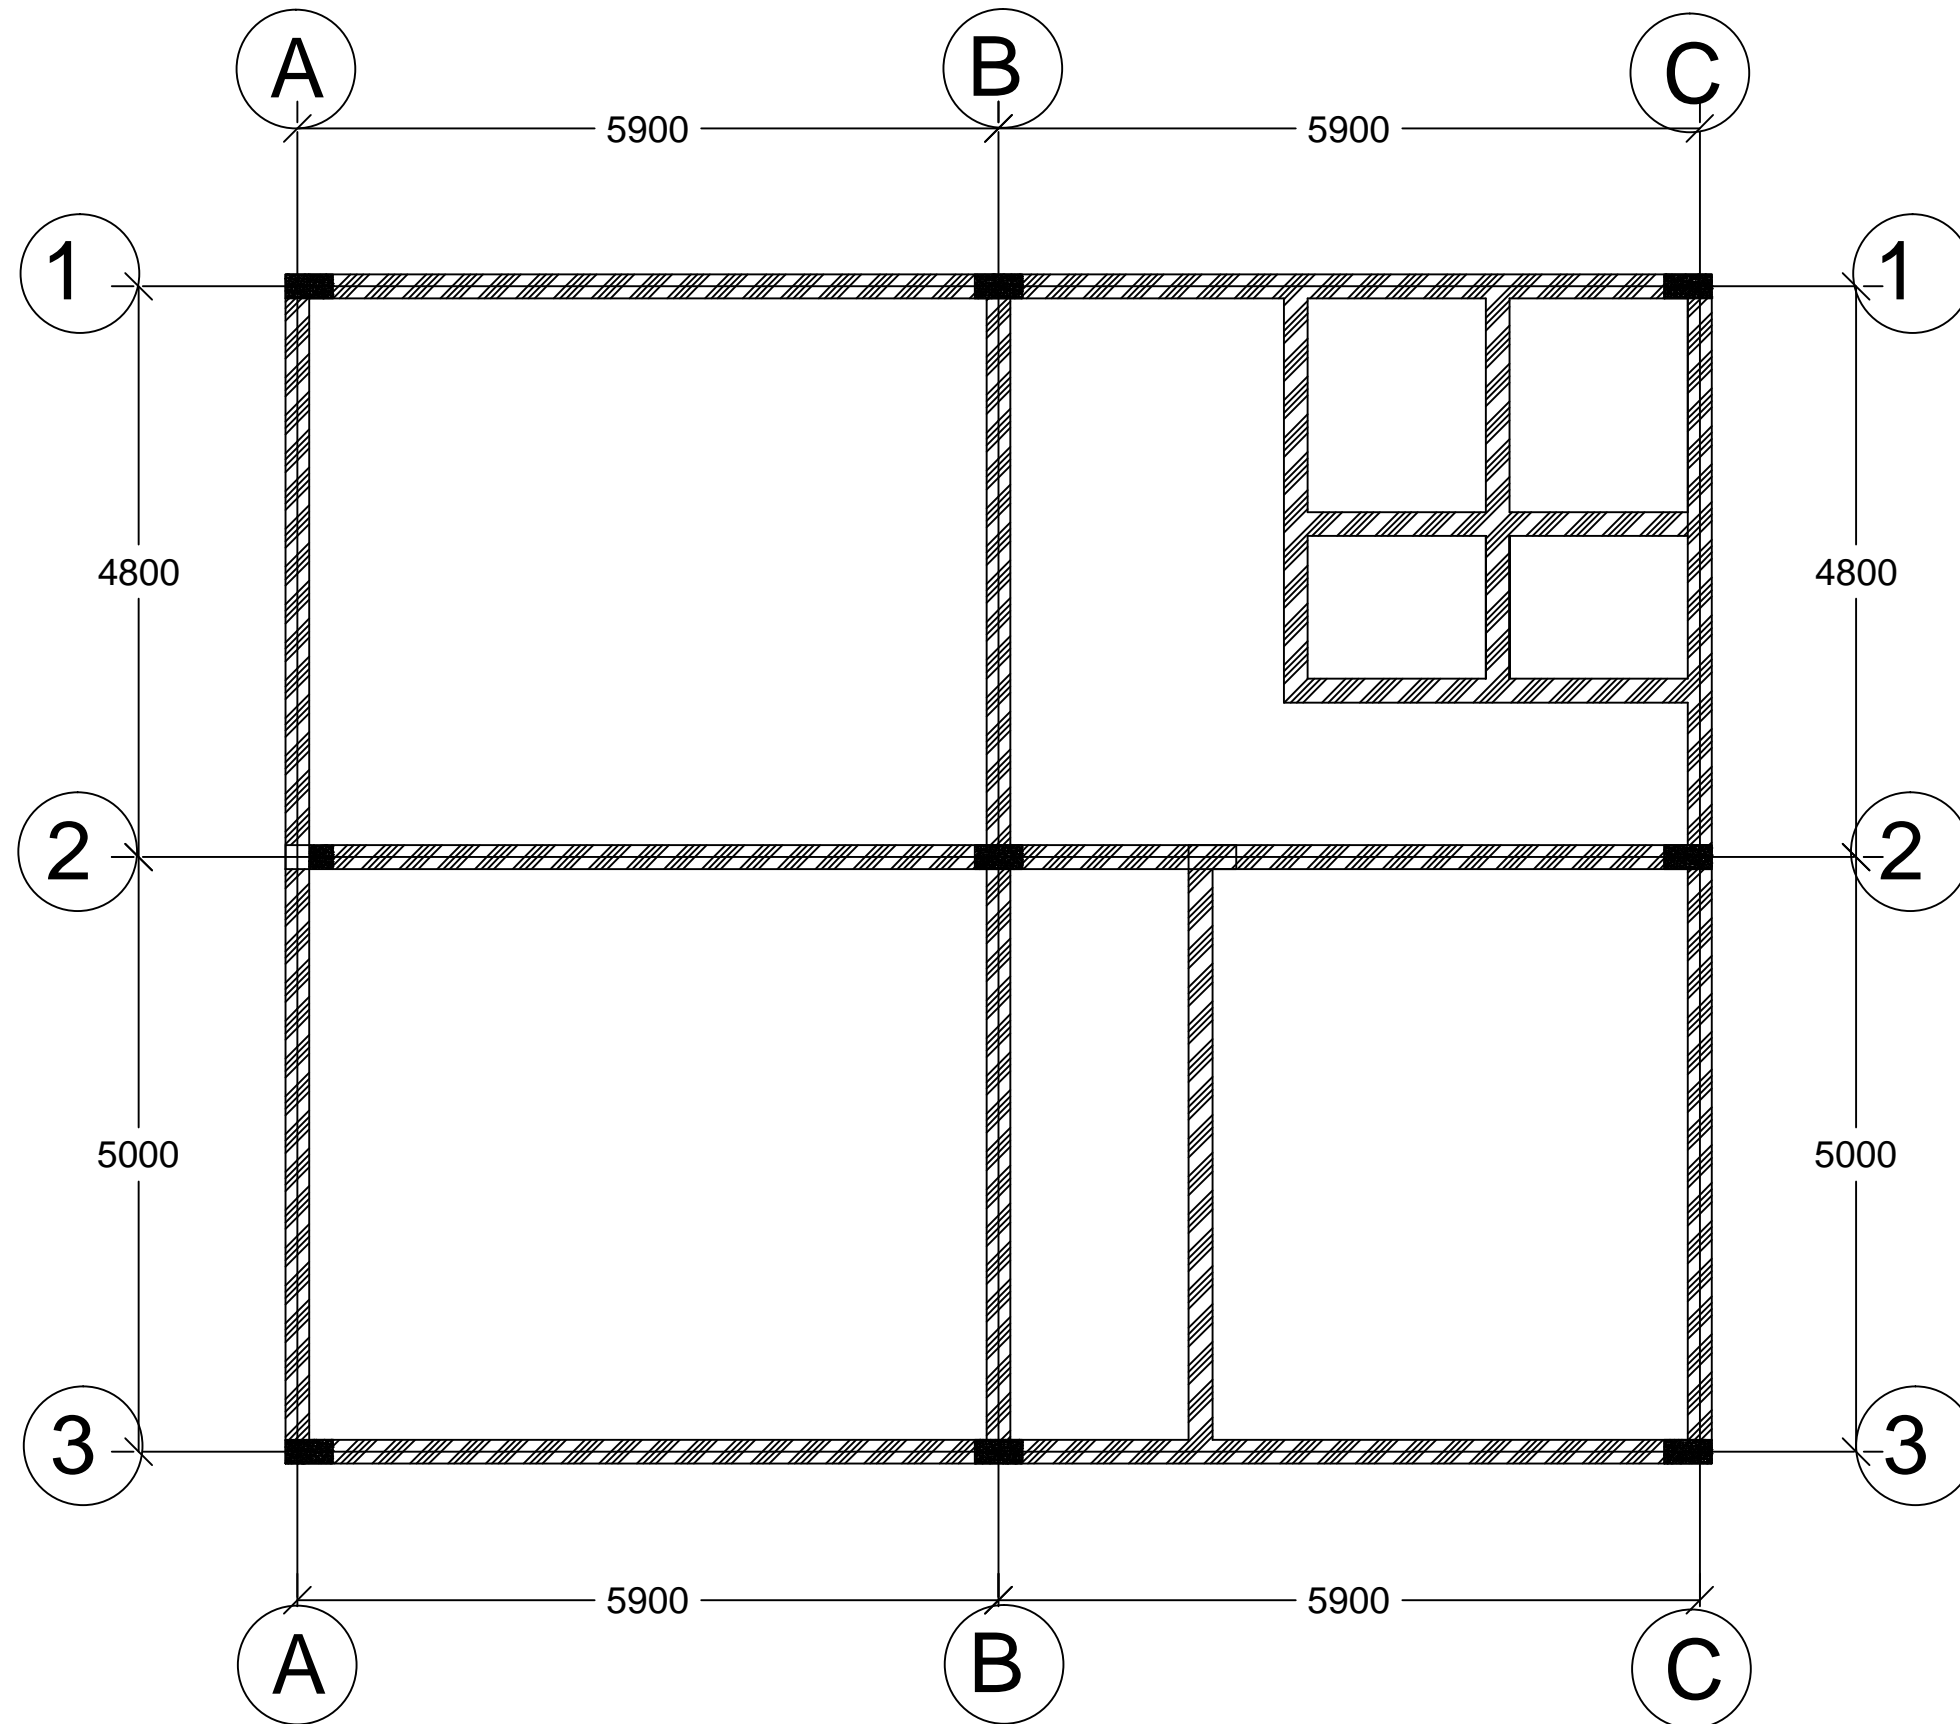

RING BEAM LAYOUT
Scale: 1:100

Client:

1. All levels and dimensions to be checked on site before any building work commence
2. All works to be strictly in accordance to with standard specification and notes
3. walls below 200mm to be reinforced with hoop iron at every alternate course.
4. This drawing is to be read in conjunction with specifications and all other relevant drawings

Client:

Nis - Foundation

project Name:

Reconstruction of Lasanod hospital

Drawing title:

Drawing title:

prepared by:

XXXXXX

checked by:

XXXXXX

Scale:

1:100


Date:

Feb - 2024

Drawing no:



0001

Revision:

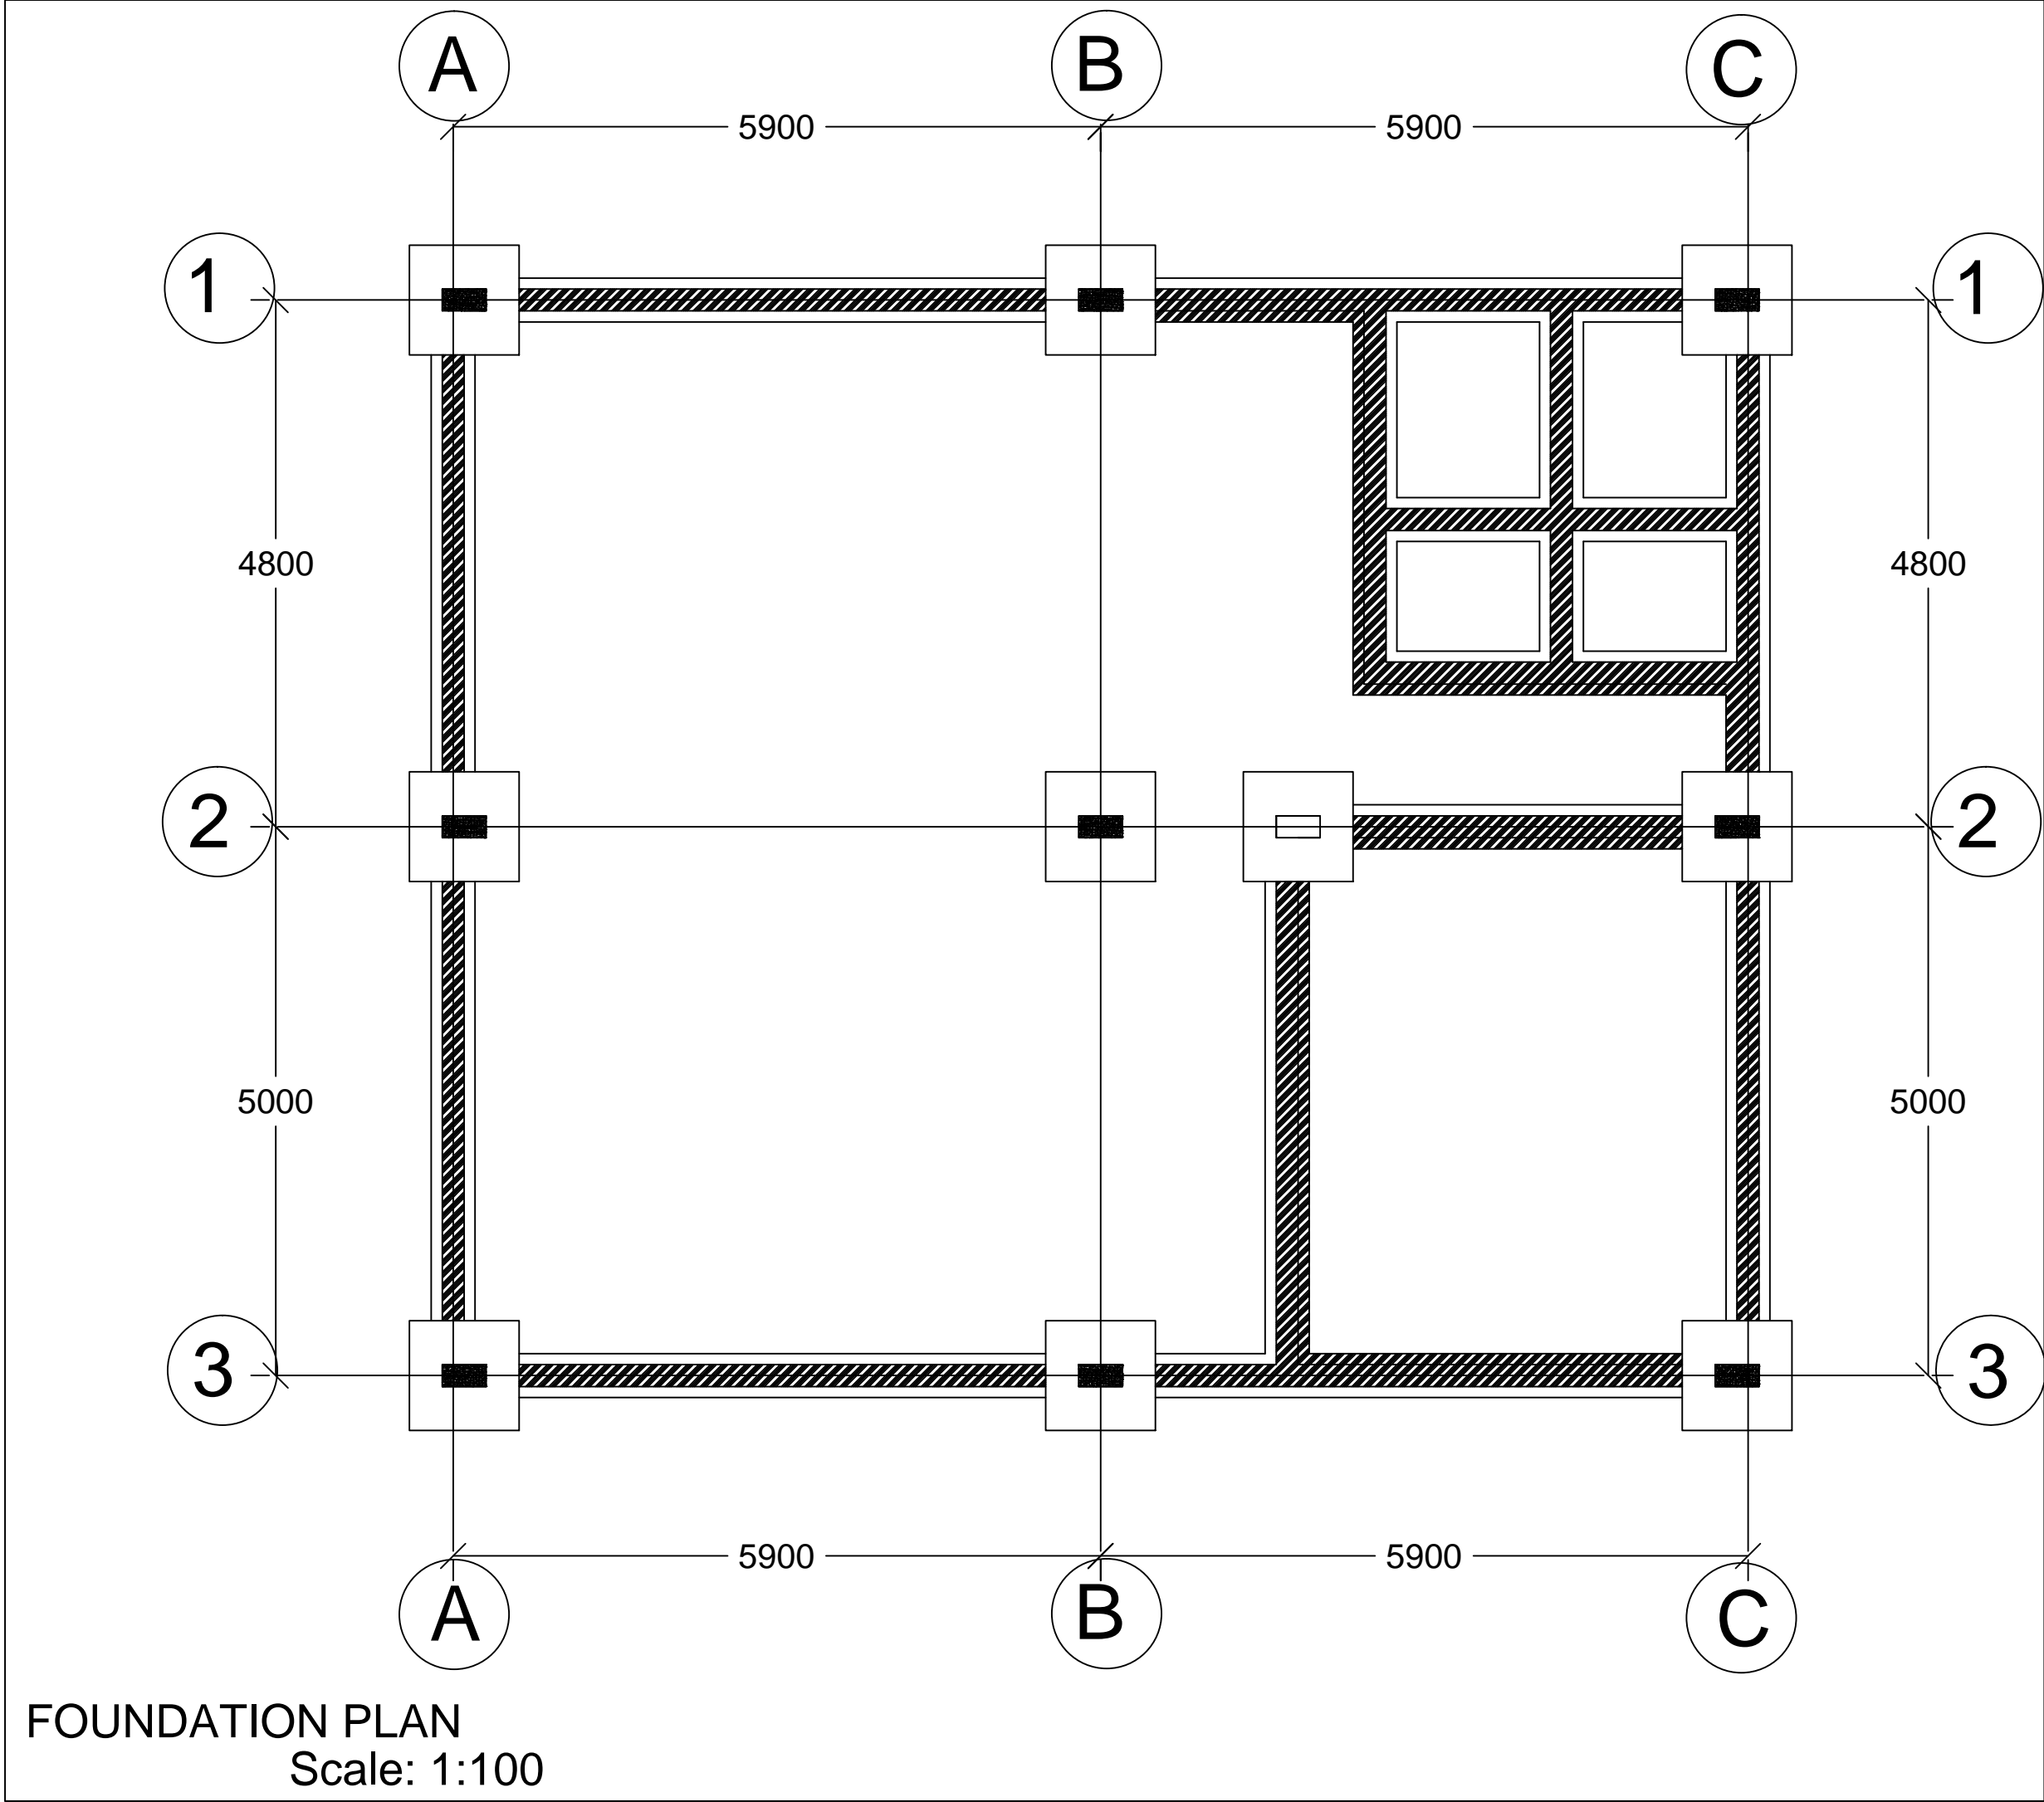

- Client:
1. All levels and dimensions to be checked on site before any building work commence
 - 2.All works to be strictly in accordance to with standard specification and notes
 3. walls below 200mm to be reinforced with hoop iron at every alternate course.
 4. This drawing is to be read in conjunction with specifications and all other relevant drawings


Client:	
Nis - Foundation	
project Name:	
Reconstruction of Lasanod hospital	
Drawing title:	
Drawing title:	
prepered by:	checked by:
XXXXXX	XXXXXX
Scale:	Date:
1:100	Feb - 2024
Drawing no:	Revision:
0001	

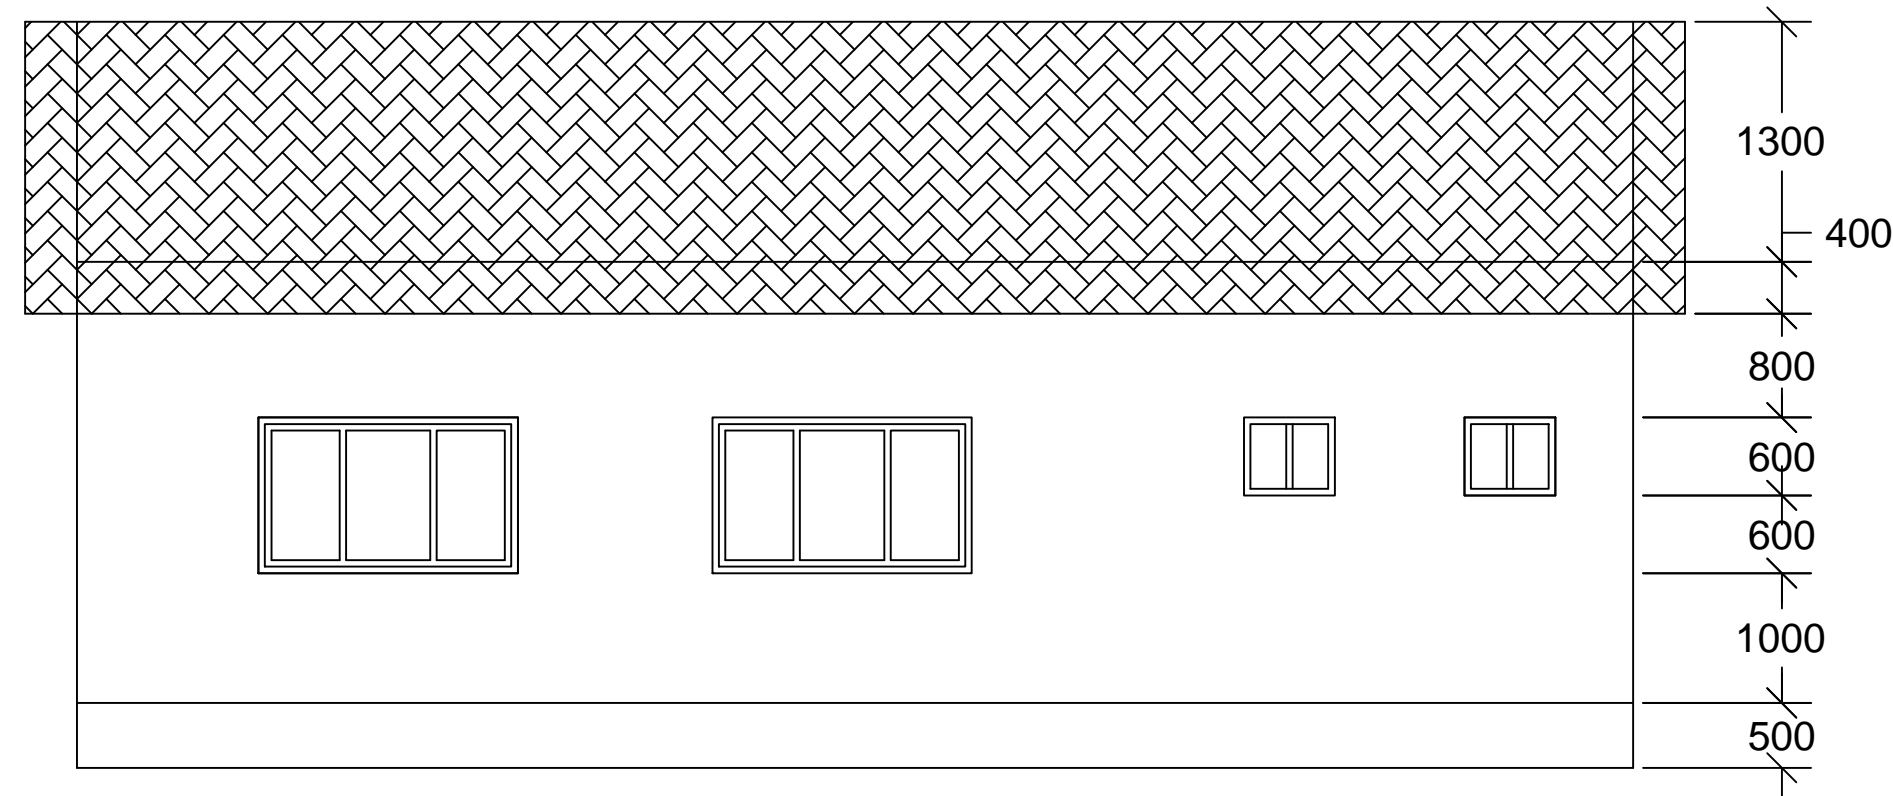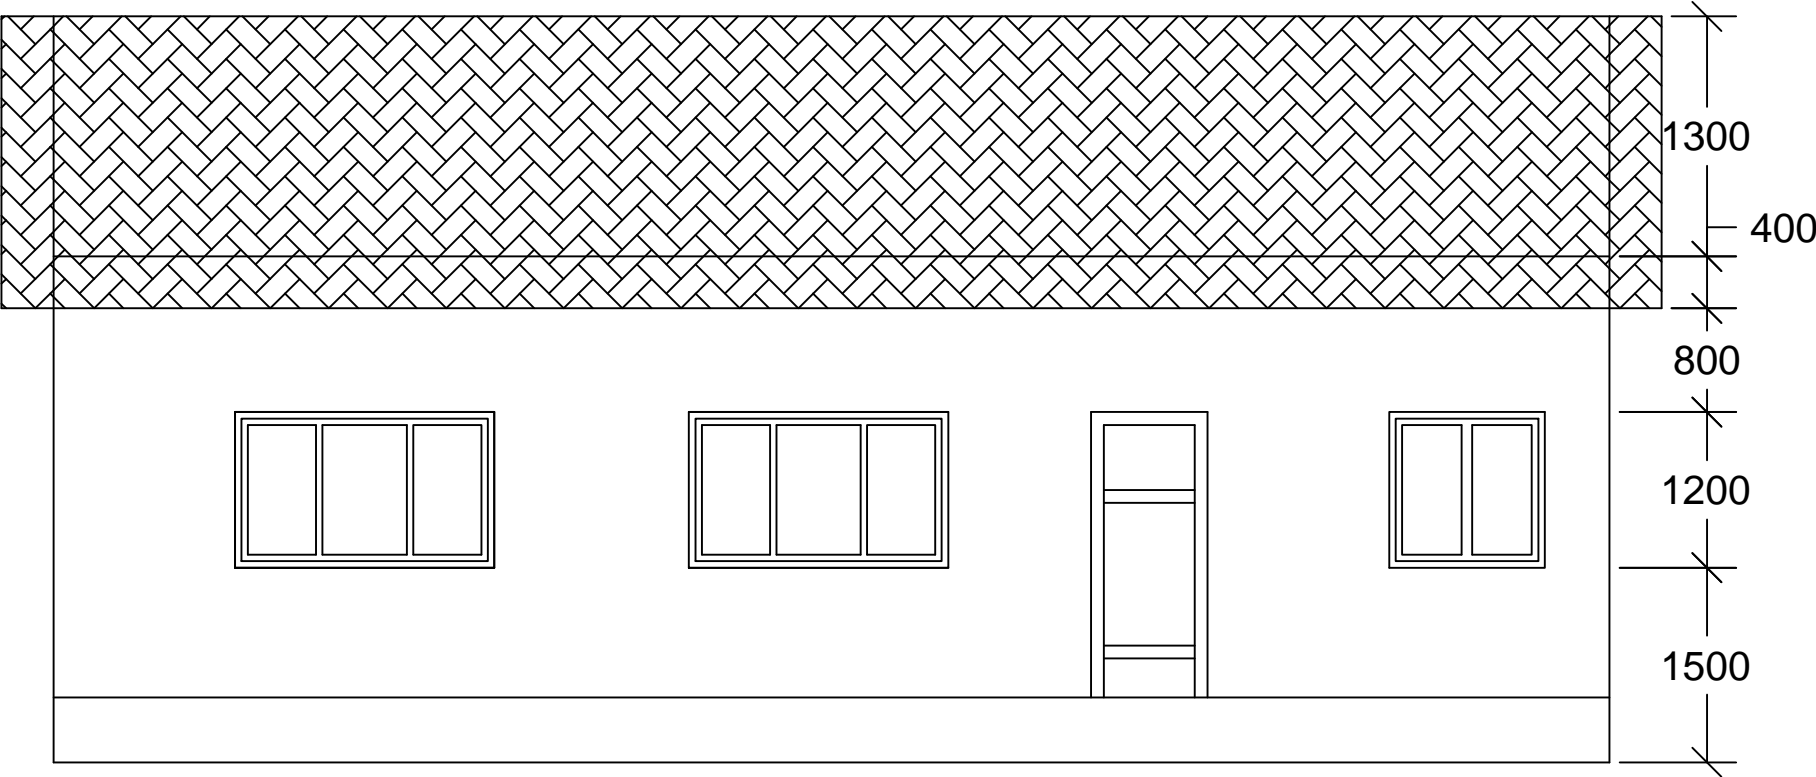

ELEVATION VIEW
Scale: 1:100


- Client:
- 1. All levels and dimensions to be checked on site before any building work commence
 - 2.All works to be strictly in accordance to with standard specification and notes
 - 3. walls below 200mm to be reinforced with hoop iron at every alternate course.
 - 4. This drawing is to be read in conjunction with specifications and all other relevant drawings

Client:	
Nis - Foundation	
project Name:	
Reconstruction of Lasanod hospital	
Drawing title:	
Drawing title:	
prepered by:	checked by:
XXXXXX	XXXXXX
Scale:	Date:
1:100	Feb - 2024
Drawing no:	Revision:
0001	

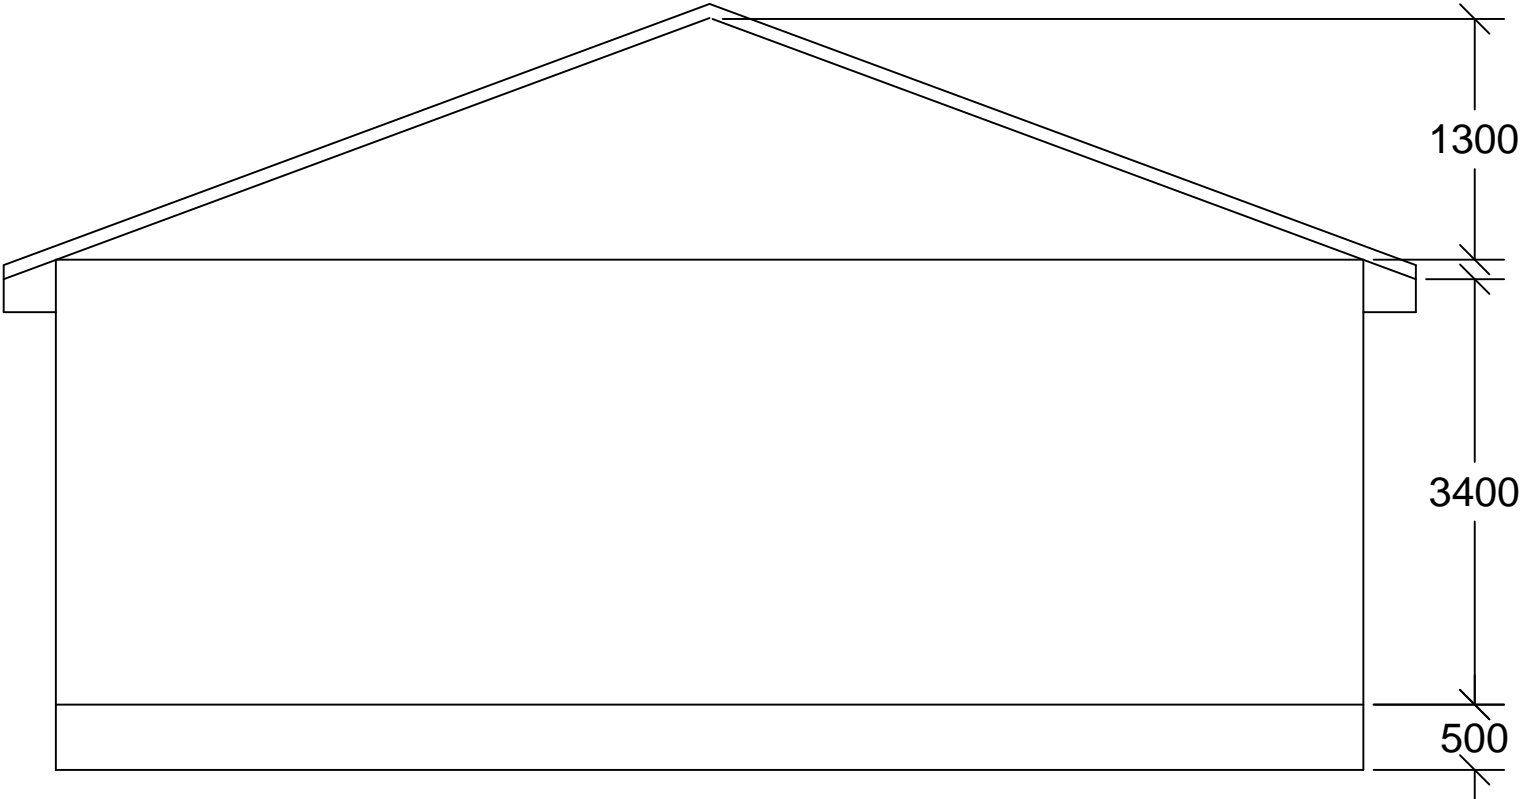

ELEVATION VIEW 01
Scale: 1:100


<div>Client:</div> <div><div>1. All levels and dimensions to be checked on site before any building work commance</div><div>2.All works to be strictly in accordance to with standard specification and notes</div><div>3. walls below 200mm to be reinforced with hoop iron at every alternate course.</div><div>4. This drawing is to be read in conjunction with specifications and all other relevant drawings</div></div>	
<div>Client:</div> <div>Nis - Foundation</div>	
<div>project Name:</div> <div>Reconstruction of Lasanod hospital</div>	
<div>Drawing title:</div> <div>Drawing title:</div>	
<div>prepered by:</div> <div>XXXXXX</div>	<div>checked by:</div> <div>XXXXXX</div>
<div>Scale:</div> <div>1:100</div>	<div>Date:</div> <div>Feb - 2024</div>
<div>Drawing no:</div> <div>0001</div>	<div>Revision:</div> <div></div>

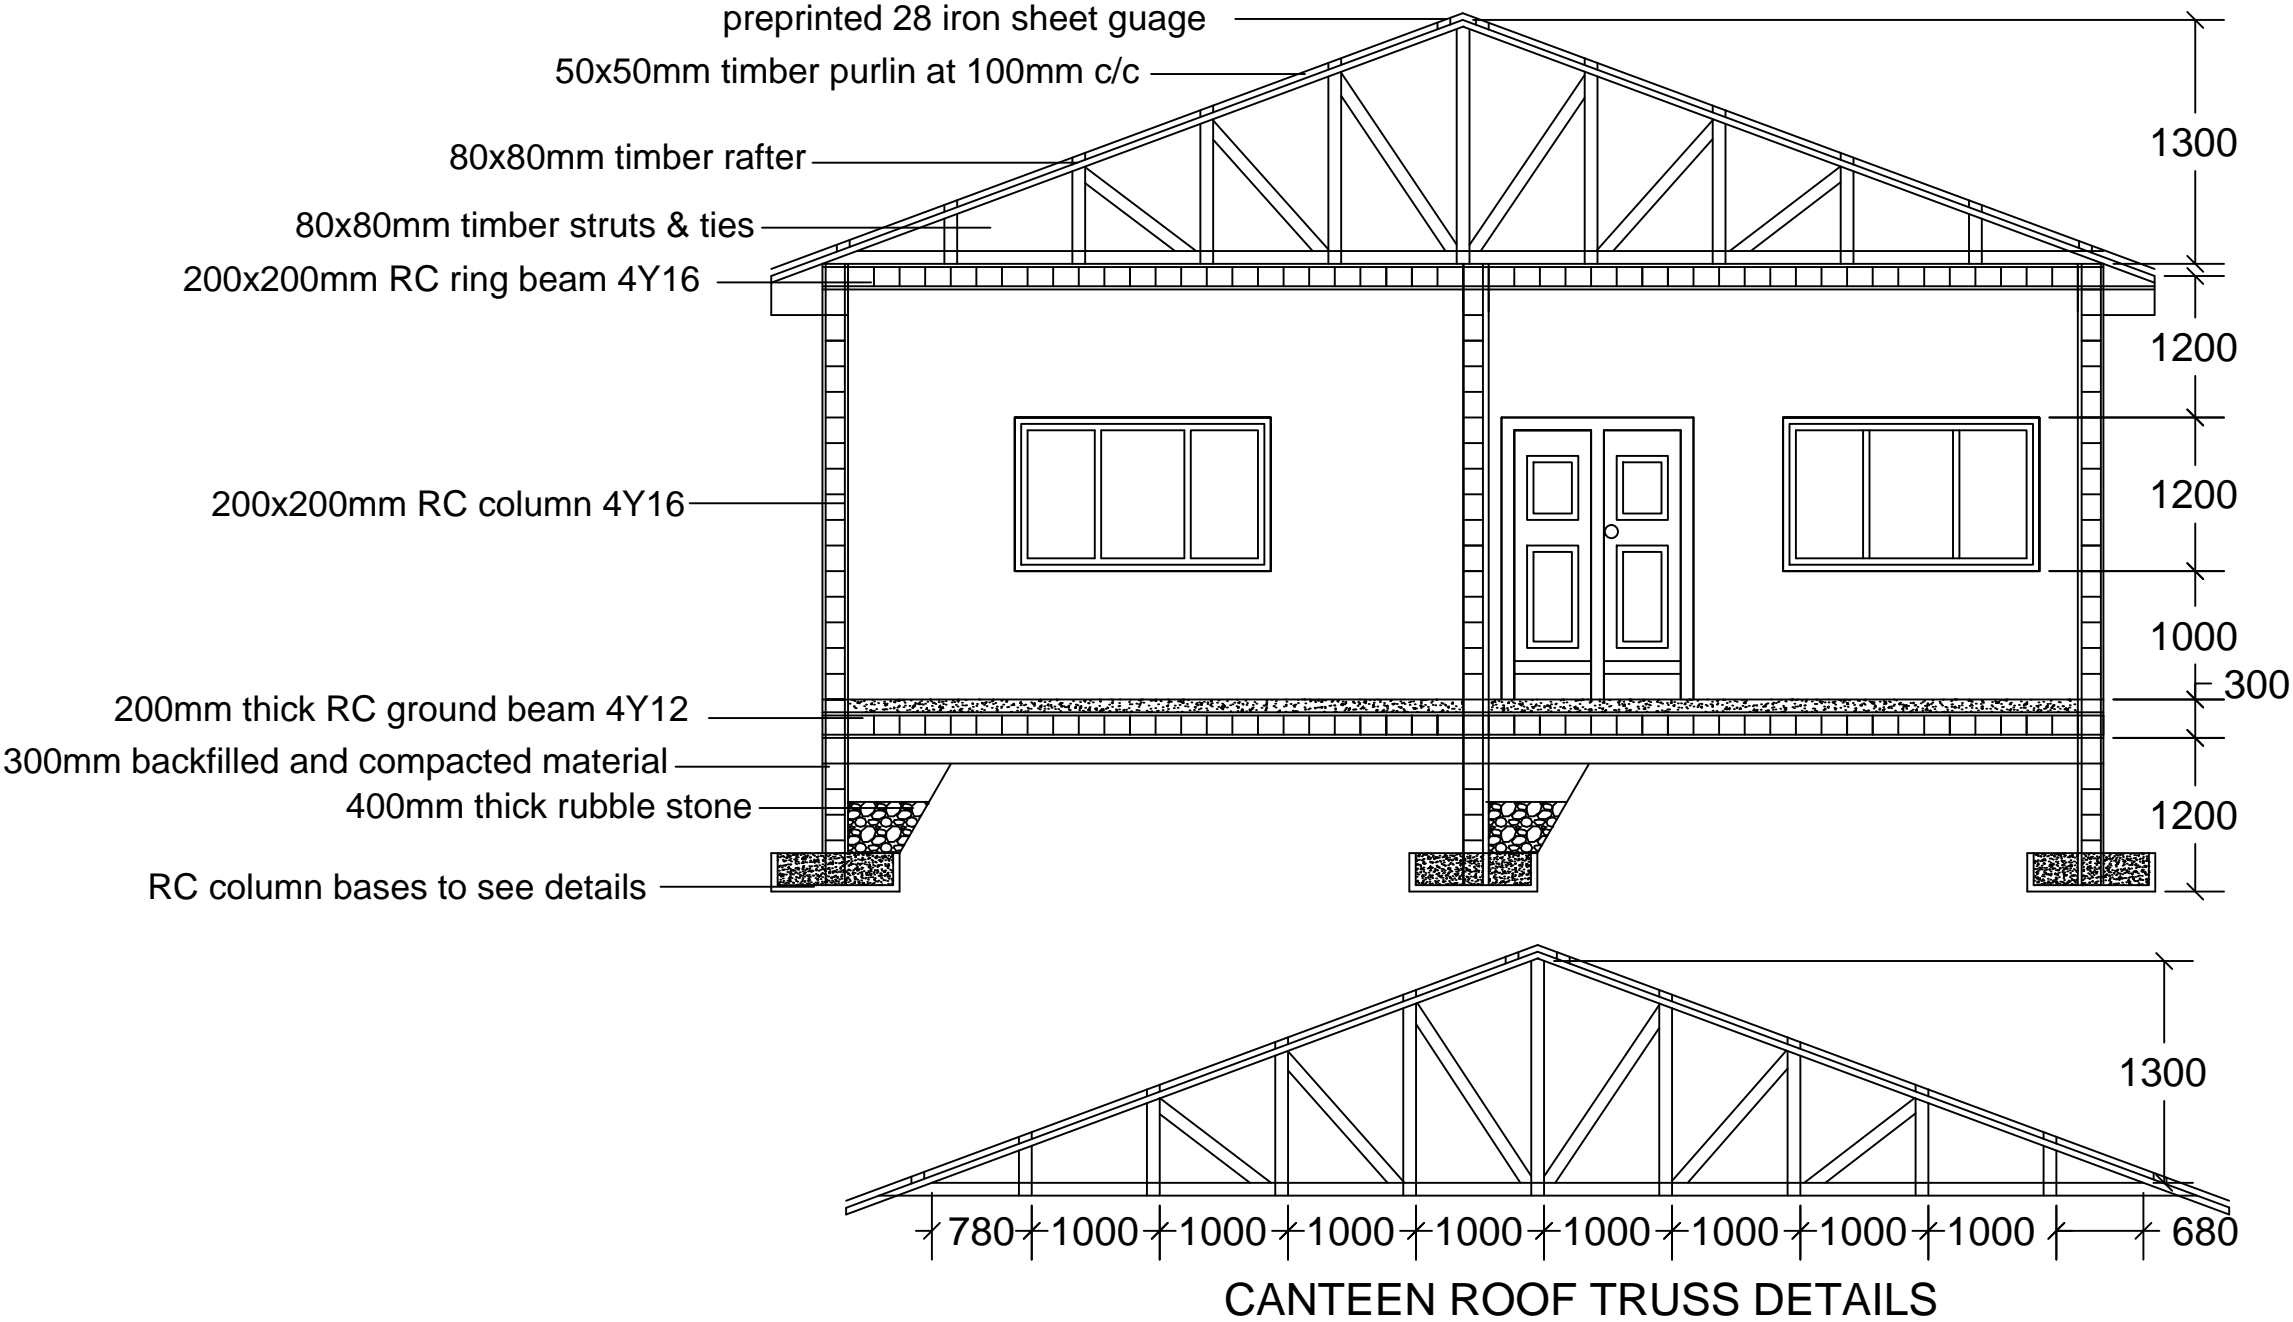

SECTION DETAILS
Scale: 1:100

- Client:
1. All levels and dimensions to be checked on site before any building work commence
 - 2.All works to be strictly in accordance to with standard specification and notes
 3. walls below 200mm to be reinforced with hoop iron at every alternate course.
 4. This drawing is to be read in conjunction with specifications and all other relevant drawings


Client:	
Nis - Foundation	
project Name:	
Reconstruction of Lasanod hospital	
Drawing title:	
Drawing title:	
prepered by: XXXXXX	checked by: XXXXXX
Scale: 1:100	Date: Feb - 2024
Drawing no: 0001	Revision:

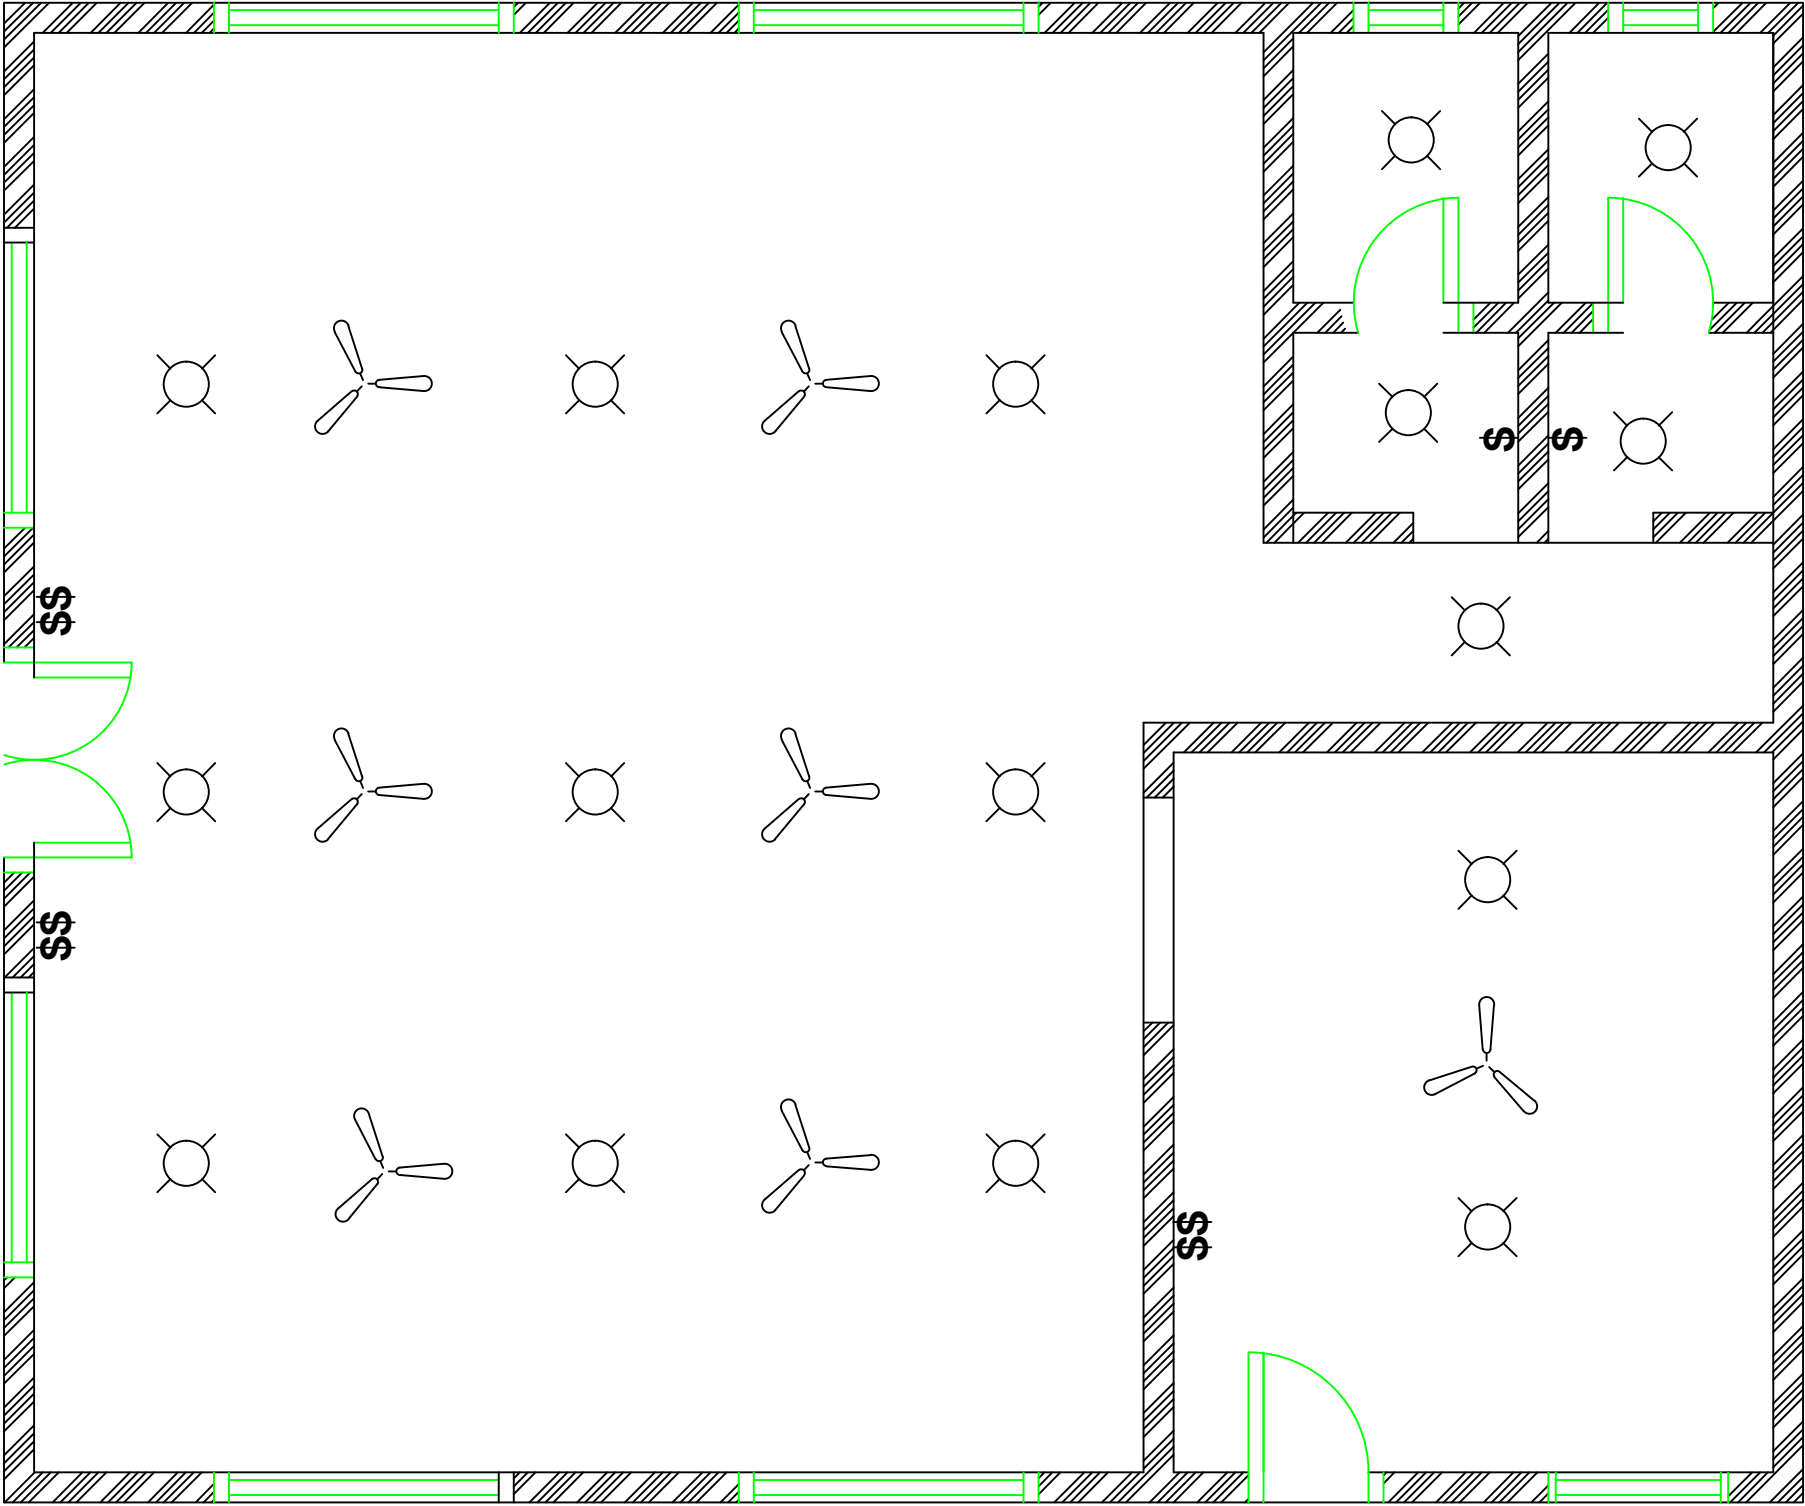

ELECTRIC PLAN LAYOUT
Scale: 1:100

- Client:**
- 1. All levels and dimensions to be checked on site before any building work commence
 - 2.All works to be strictly in accordance to with standard specification and notes
 - 3. walls below 200mm to be reinforced with hoop iron at every alternate course.
 - 4. This drawing is to be read in conjunction with specifications and all other relevant drawings

Client:	
Nis - Foundation	
project Name:	
Reconstruction of Lasanod hospital	
Drawing title:	
Drawing title:	
prepered by: XXXXXX	checked by: XXXXXX
Scale: 1:100	Date: Feb - 2024
Drawing no: 0001	Revision:

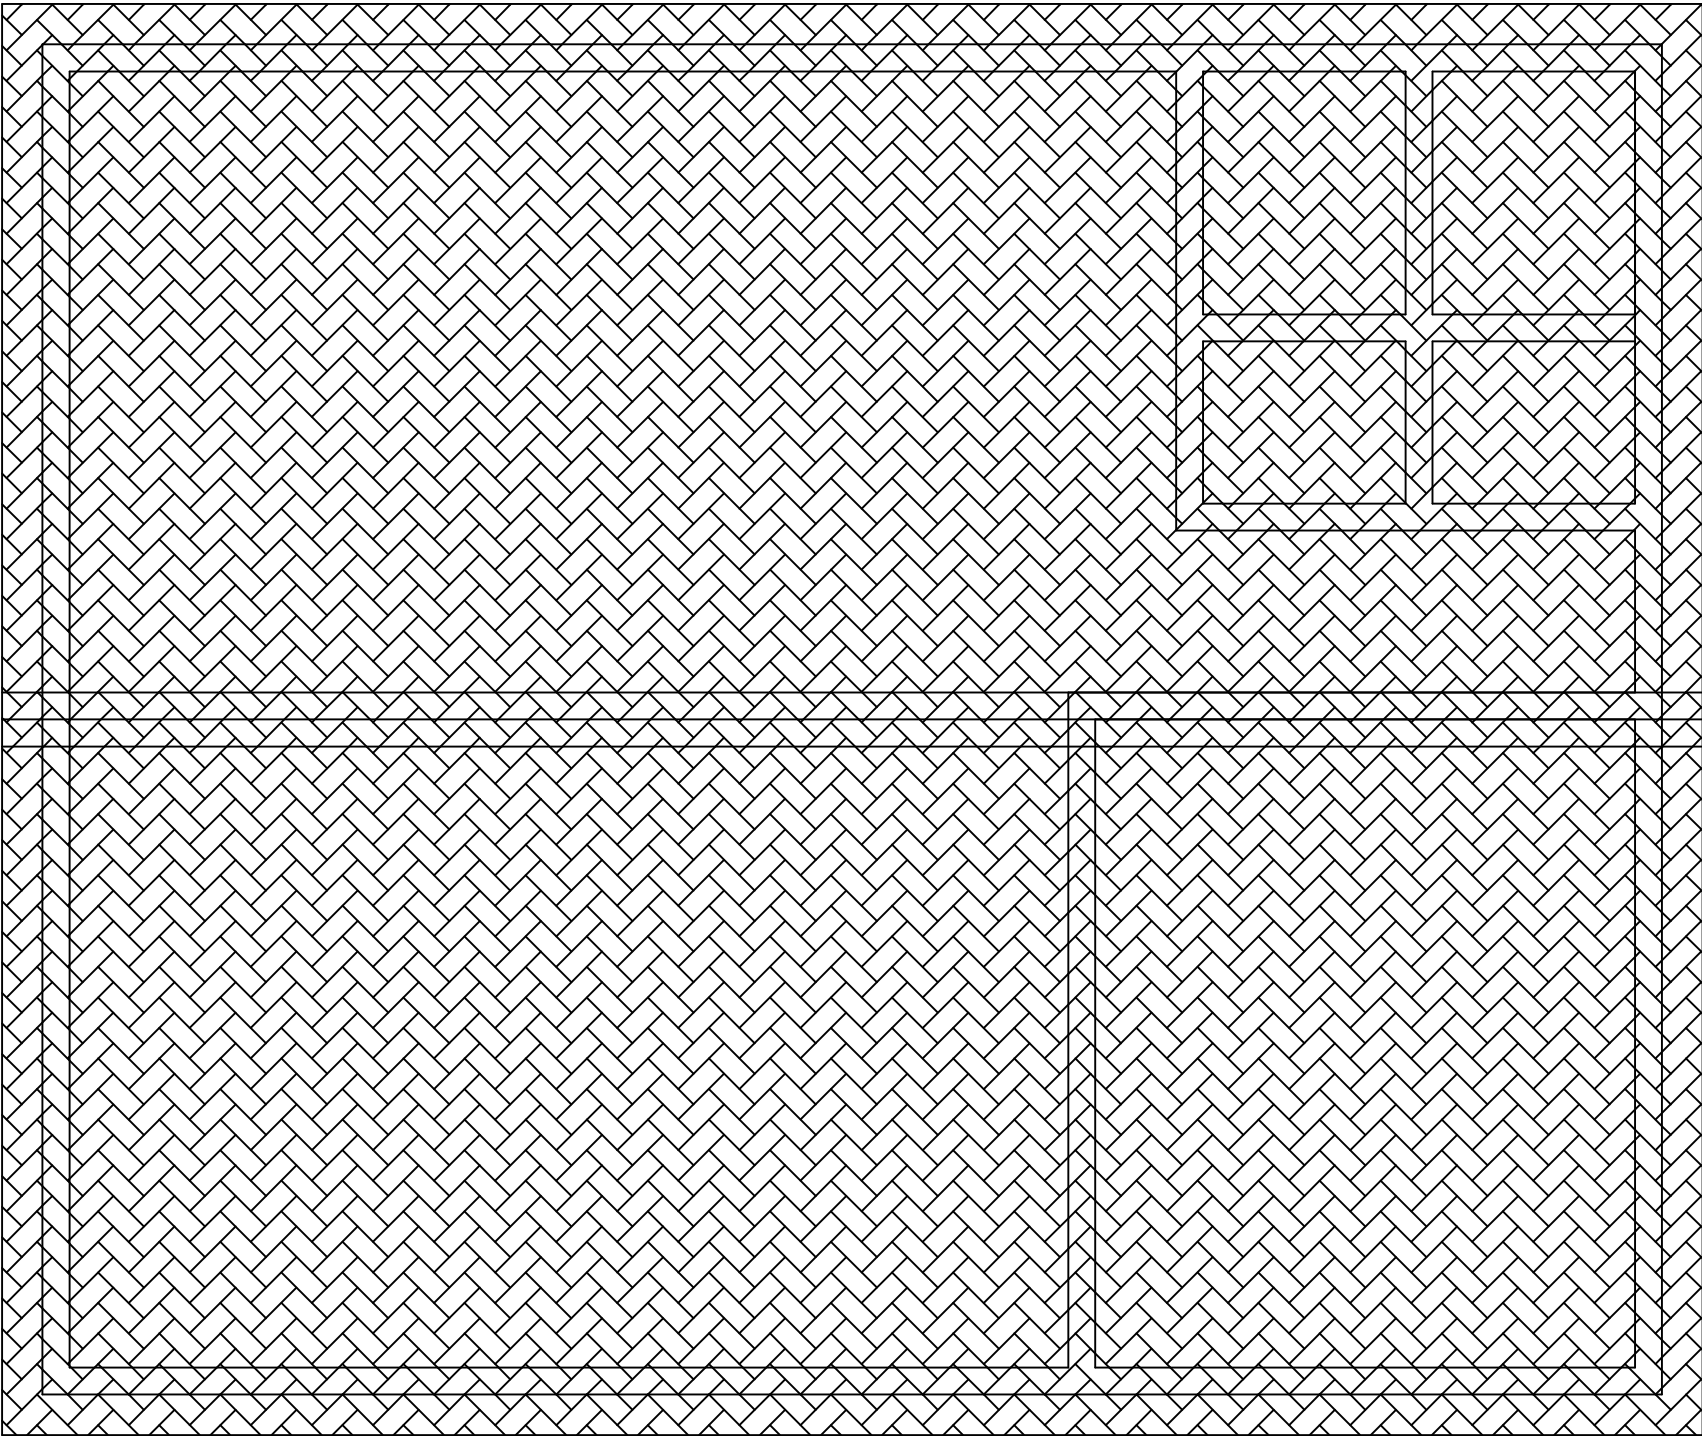

ROOF PLAN LAYOUT
Scale: 1:100

- Client:
- 1. All levels and dimensions to be checked on site before any building work commence
 - 2.All works to be strictly in accordance to with standard specification and notes
 - 3. walls below 200mm to be reinforced with hoop iron at every alternate course.
 - 4. This drawing is to be read in conjunction with specifications and all other relevant drawings

Client:	
Nis - Foundation	
project Name:	
Reconstruction of Lasanod hospital	
Drawing title:	
Drawing title:	
prepered by:	checked by:
XXXXXX	XXXXXX
Scale:	Date:
1:100	Feb - 2024
Drawing no:	Revision:
0001	


- Client:
1. All levels and dimensions to be checked on site before any building work commence

2.All works to be strictly in accordance to with standard specification and notes


3. walls below 200mm to be reinforced with hoop iron at every alternate course.

4. This drawing is to be read in conjunction with specifications and all other relevant drawings


Client:	
Nis - Foundation	
project Name:	
Reconstruction of Lasanod hospital	
Drawing title:	
Drawing title:	
prepered by:	checked by:
XXXXXX	XXXXXX
Scale:	Date:
1:100	Feb - 2024
Drawing no:	Revision:
0001	

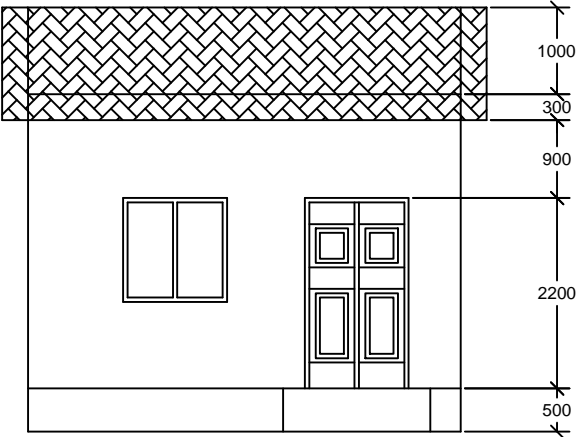


FRONT ELEVATION

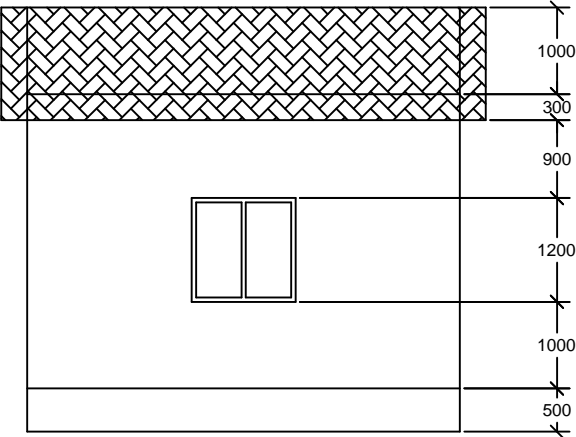

BACK SIDE ELEVATION

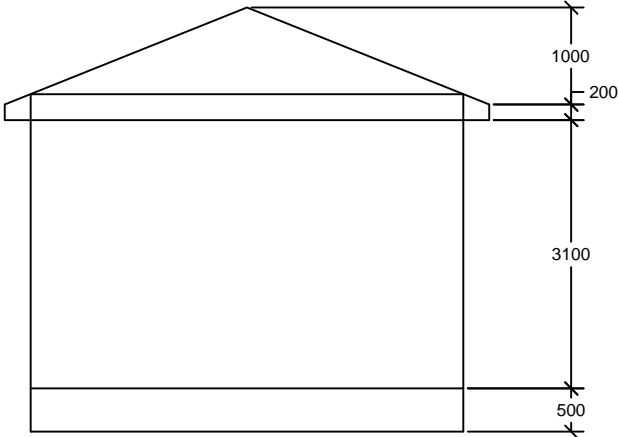


SIDE ELEVATION

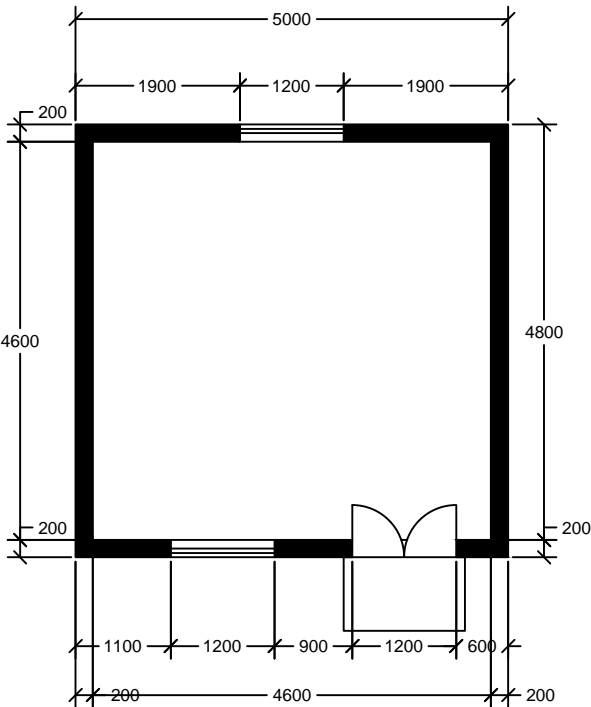


FLOOR PLAN LAYOUT MORTUARY ROOM



SCALE: 1:100

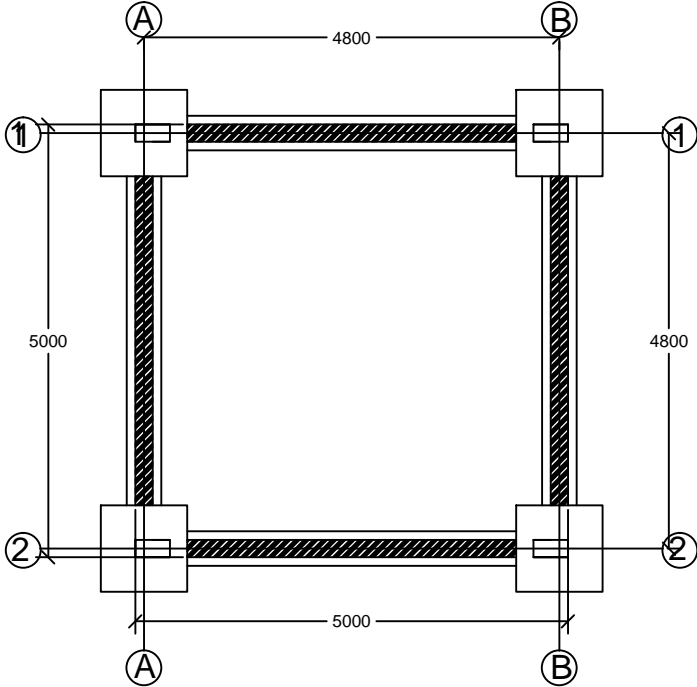


FOUNDATION PLAN LAYOUT

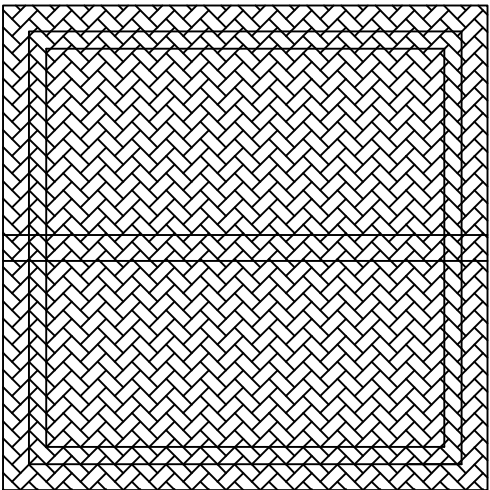


ROOF PLAN LAYOUT

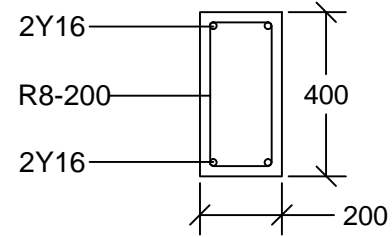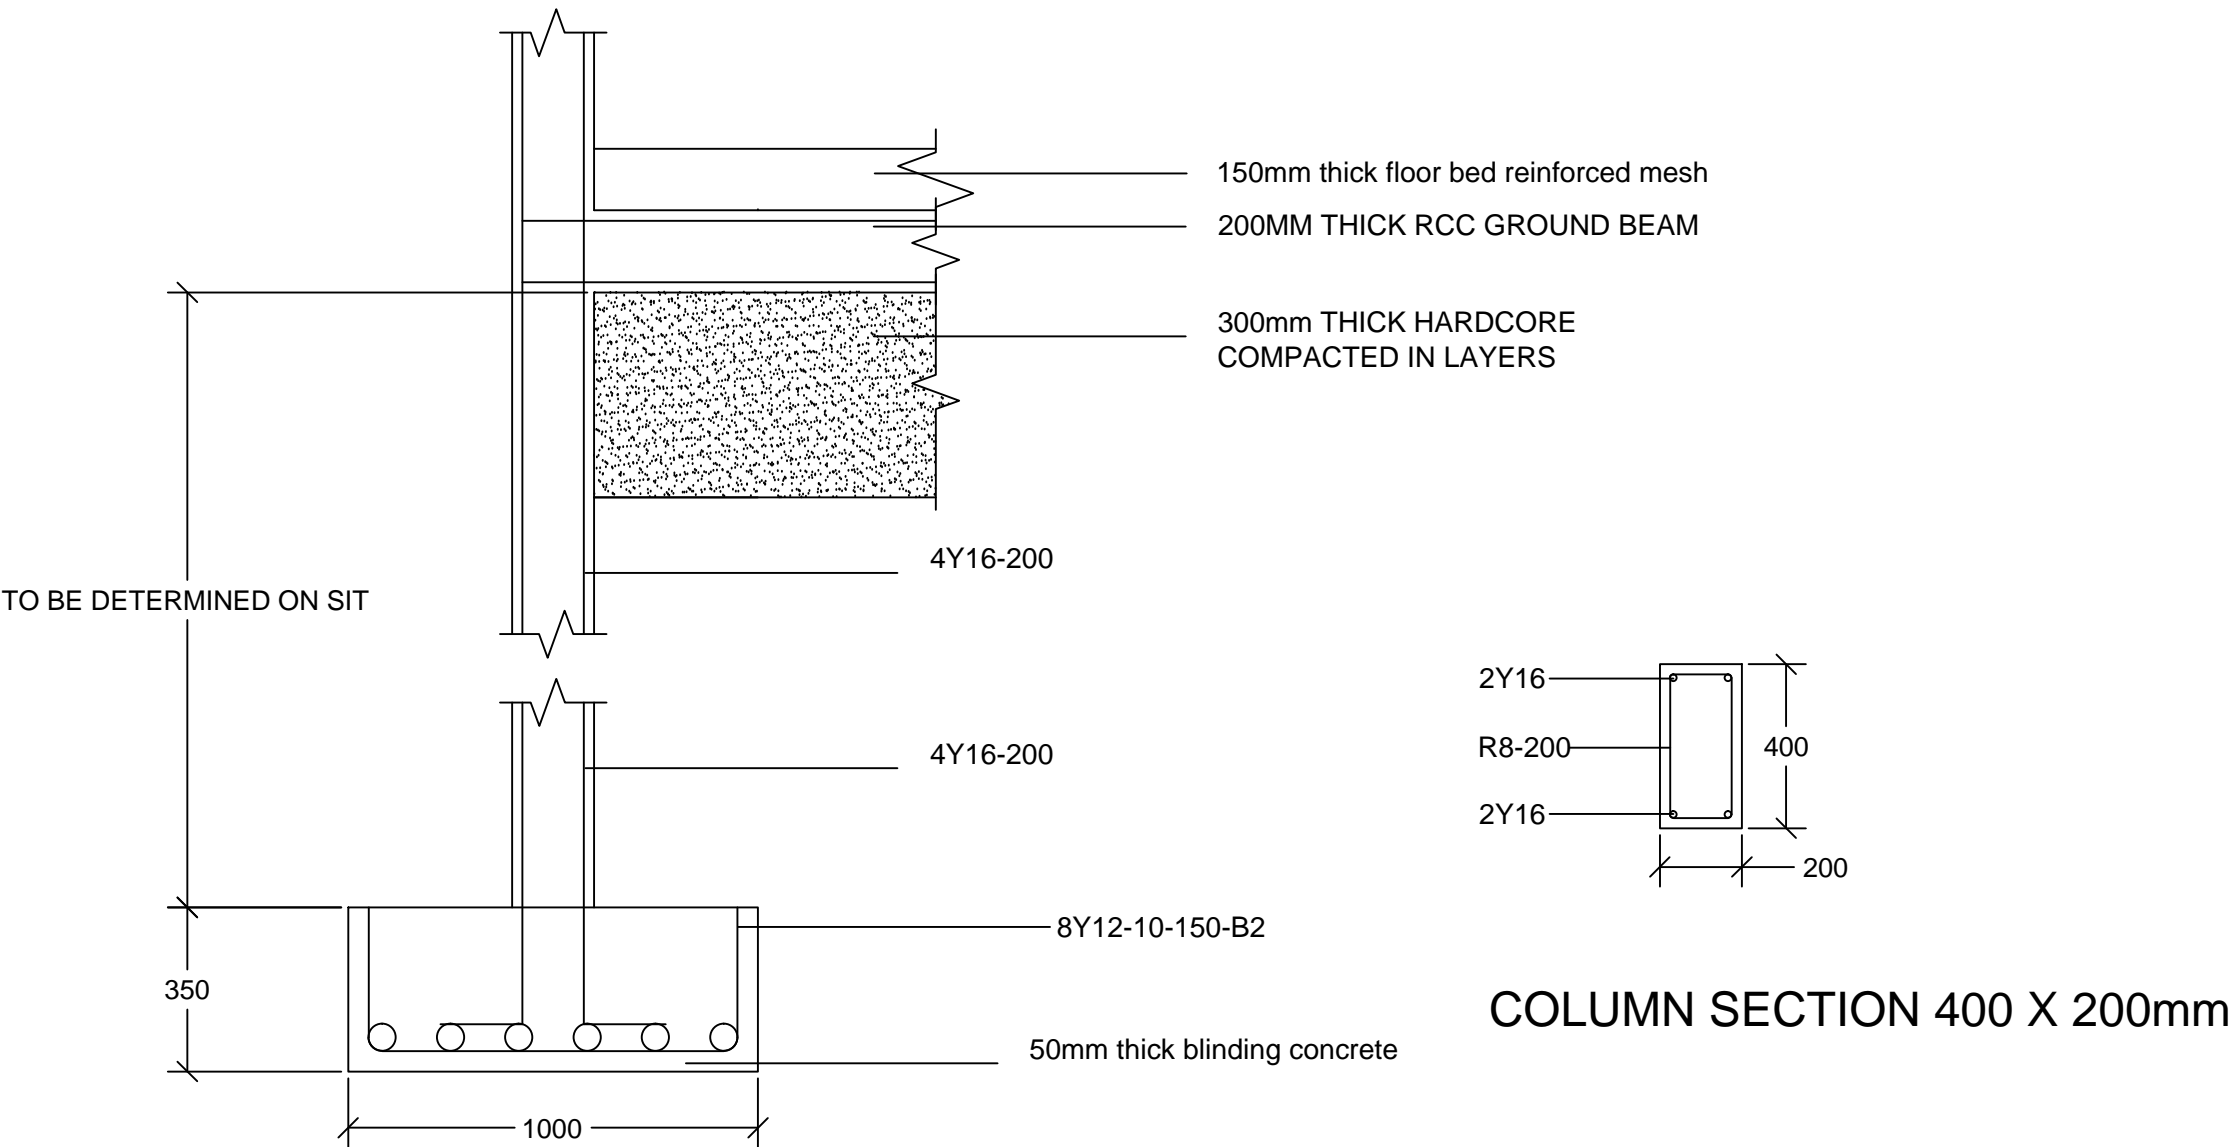

COLUMN SECTION 400 X 200mm

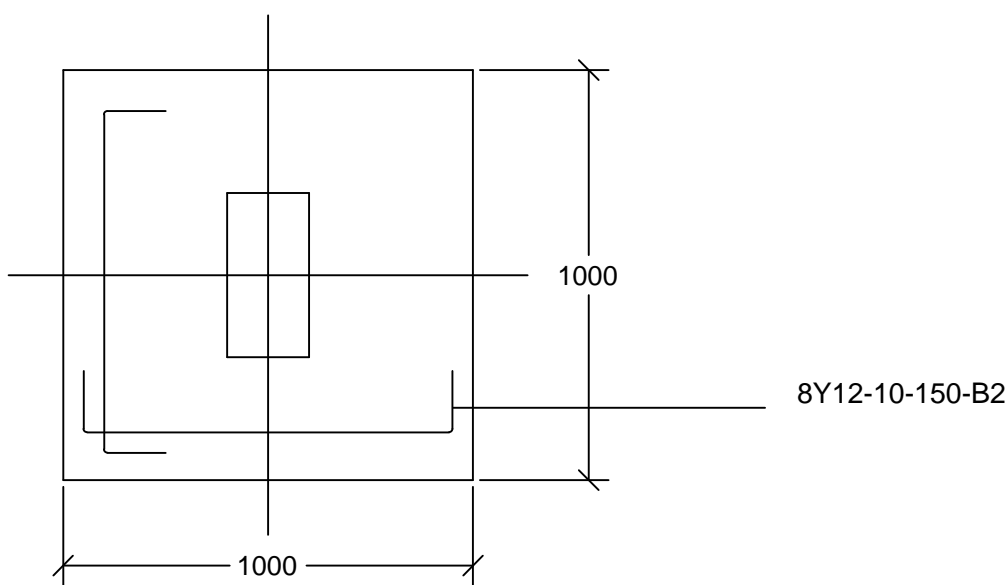

COLUMN BASE 1000 x 1000mm

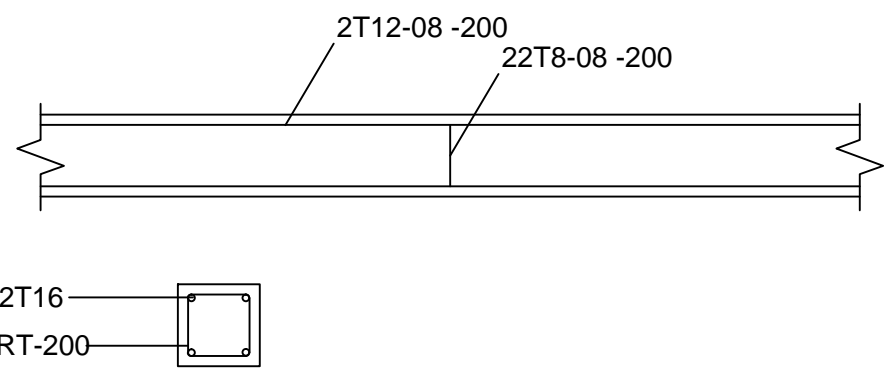

RING BEAM SECTION 200 X 200mm

- Client:
1. All levels and dimensions to be checked on site before any building work commance
 - 2.All works to be strictly in accordance to with standard specification and notes
 3. walls below 200mm to be reinforced with hoop iron at every alternate course.
 4. This drawing is to be read in conjunction with specifications and all other relevant drawings

Client:

Nis - Foundation

project Name:

Reconstruction of Lasanod hospital

Drawing title:

Drawing title:

prepered by: XXXXXX	checked by: XXXXXX
Scale: 1:100	Date: Feb - 2024
Drawing no: 0001	Revision: